

SECURITY REQUIREMENTS

GENERAL:

1. ALL ENTRY DOORS TO DWELLING UNITS OR GUEST ROOMS SHALL BE ARRANGED SO THAT THE OCCUPANT HAS A VIEW OF THE ERA IMMEDIATELY OUTSIDE THE DOOR WITHOUT OPENING THE DOOR. SUCH VIEW MAY BE PROVIDED BY A DOOR VIEWER, THROUGH WINDOWS LOCATED IN THE VICINITY OF THE DOOR OR THROUGH VIEW PORTS IN THE DOOR OR ADJOINING WALL.

2. SCREENS, BARRICADES, OR FENCES MADE OF MATERIAL WHICH PRECLUDE HUMAN CLIMBING SHALL BE PROVIDED AT EVERY PORTION OF EVERY ROOF, BALCONY, OR SIMILAR SURFACE WHICH IS WITHIN 8 FT. OF THE UTILITY POLE OR SIMILAR STRUCTURES.

DOORS:

3. WOOD FLUSH-TYPE DOORS SHALL BE 1 3/8" THICK MINIMUM WITH SOLID CORE CONSTRUCTION. 91.6709.1 – DOOR STOPS OF IN SWINGING DOORS SHALL BE OF ONE-PIECE CONSTRUCTION WITH THE JAMB OR JOINED BY RABBIT OR THE JAMB.

4. EVERY DOOR IN SECURITY OPENING FOR AN APARTMENT HOUSE SHALL BE PROVIDED WITH A LIGHT BULB 960 WATT MIN.) AT A MAXIMUM HEIGHT OF 8 FEET ON THE EXTERIOR.

5. ALL PIN-TYPE DOOR HINGES ACCESSIBLE FROM OUTSIDE SHALL HAVE NON-REMOVABLE HINGE PINS. HINGES SHALL HAVE MIN. 1/4" DIA. STEEL JAMB STUD WITH 3/4" MIN. PROTECTION. THE STRIKE PLATE OF LATCHES AND HOLDING DEVICE FOR PROJECTING DEAD BOLTS IN WOOD CONSTRUCTION SHALL BE SECURED TO THE JAMB AND THE WALL. FRAMING WITH SCREWS NO LESS THAN 2-1/2" LONG.

6. PROVIDE DEAD BOLTS WITH HARDENED INSERTS; DEADLOCKING LATCH WITH KEY-OPERATED LOCKS ON EXTERIOR. LOCKS MUST BE OPENABLE FROM INSIDE WITHOUT KEY, SPECIAL KNOWLEDGE OR SPECIAL EFFORT (LATCH NOT REQUIRED IN B, F, AND S OCCUPANCIES. 91.6709.2

7. STRAIGHT DEAD BOLTS SHALL HAVE A MIN. THROW OF 1" AND AN EMBEDMENT OF NOT LESS THAN 5/8", AND A HOOK-SHAPED OR AN EXPANDING-LUG DEADBOLT SHALL HAVE A MINIMUM THROW OF 2" 91.6709.2

8. THE USE OF A LOCKING SYSTEM WHICH CONSISTS OF A DEADLOCKING LATCH OPERATED BY ADORNOROB AND A DEADBOLT OPERATED BYA NON-REMOVABLE THUMB TURN WHICH IS INDEPENDENT OF THE DEADLOCKING LATCH AND WHICH MUST BE SEPARATELY OPERATED, SHALL NOT BE CONSIDERED AS A SYSTEM WHICH REQUIRES SPECIAL KNOWLEDGE OR EFFORT WHEN USED I DWELLING UNITS. THE DOOR KNOB AND THE THUMB TURN WHICH OPERATES THE DEADBOLT SHALL NOT BE SEPARATED BY MORE THAN 8 INCHES.

9. WOOD PANEL TYPE DOORS MUST HAVE PANELS AT LEAST 9/16 IN. THICK WITH SHAPED PORTIONS NOT LESS THAN 3/4 IN. THICK AND INDIVIDUAL PANELS MUST BE NO MORE THAN 300 SQ. IN. IN AREA. MULLIONS SHALL BE CONSIDERED A PART OF ADJACENT PANELS EXCEPT MULLIONS NOT OVER 18 INCHES LONG MAY HAVE AN OVERALL WIDTH OF NOT LESS THAN 2 INCHES. STILES AND RAILS SHALL BE OF SOLID LUMBER IN THICKNESS WITH OVERALL DIMENSIONS OF NOT LESS THAN 1 3/8 INCHES AND 3 INCHES IN WIDTH. 91.6709.1 ITEM 2

OTHER OPENABLE WINDOWS SHALL BE PROVIDED WITH SUBSTANTIAL LOCKING DEVICES. IN B, F, M AND S OCCUPANCIES , SUCH DEVICES SHALL BE GLIDE BARS, BOLTS, CROSS-BARS, AND/OR PADLOCKS WITH MINIMUM 9/32" HARDENED STEEL SHACKLES AND BOLTED, HARDENED STEEL HASPS.

10. SLIDING WINDOWS SHALL BE PROVIDED WITH A DEVICE IN THE UPPER CHANNEL OF THE MOVING PANEL TO PROHIBIT RAISING AND REMOVING OF THE MOVING PANEL IN THE CLOSED OR PARTIALLY OPEN POSITION.

11. SLIDING WINDOWS SHALL BE EQUIPPED WITH LOCKING DEVICES AND SHALL BE SO CONSTRUCTED AND INSTALLED THAT THEY REMAIN INTACT AND ENGAGED WHEN SUBJECTED TO THE TESTS SPECIFIED IN 91.6717.2

NOTES:

1. AN APPROVED SEISMIC GAS SHUTOFF VALVE WILL BE INSTALLED ON THE FUEL GAS LINE ON THE DOWN STREAM SIDE OF THE UTILITY METER AND BE RIGIDLY CONNECTED TO THE EXTERIOR OF THE BUILDING OR STRUCTURE CONTAINING THE FUEL GAS PIPING.

2. 12" X 12" PLUMBING ACCESS FOR TUBS

3. ALL PLUMBING WALLS MIN. 2"x6"

4. SMOKE & CARBON MONOXIDE DETECTORS:

– 120V HARD-WIRED SMOKE ALARMS WITH BATTERY BACK-UP SHALL BE INSTALLED IN ALL OF THE FOLLOWING LOCATIONS: EACH BEDROOM, ON CEILING OR WALL OUTSIDE OF EACH SEPARATE BEDROOM, AND ON EACH STORY, INCLUDING BASEMENTS (NEW CONSTRUCTION), WHERE MORE THAN ONE SMOKE ALARM IS REQUIRED TO BE INSTALLED WITHIN AN INDIVIDUAL DWELLING OR SLEEPING UNIT, THE SMOKE ALARMS SHALL BE INTERCONNECTED IN SUCH A MANNER THAT THE ACTIVATION OF ONE WILL ACTIVATE ALL THE ALARMS IN THE INDIVIDUAL UNIT. THE ALARM SHALL BE CLEARLY AUDIBLE IN ALL BEDROOMS OVER BACKGROUND NOISE LEVELS WITH ALL INTERVENING DOORS CLOSED. (CRC R314.1)

– AN APPROVED CARBON MONOXIDE DETECTOR RECEIVING ITS PRIMARY SOURCE OF POWER FROM THE BUILDING WIRING AND HAVING BATTERY BACK-UP SHALL BE INSTALLED OUTSIDE OF EACH SEPARATE SLEEPING AREA OR BEDROOM(S) AND ONE ON EVERY LEVEL OF THE DWELLING INCLUDING BASEMENTS. WHERE MORE THAN ONE ALARM IS REQUIRED TO BE INSTALLED WITHIN AN INDIVIDUAL DWELLING OR SLEEPING UNIT, THE ALARMS SHALL BE INTERCONNECTED IN SUCH A MANNER THAT THE ACTIVATION OF ONE WILL ACTIVATE ALL ALARMS IN THE INDIVIDUAL UNIT. THE ALARM IS PERMITTED TO BE SOLELY BATTERY OPERATED WHERE THE WORK DOES NOT RESULT IN THE REMOVAL OF WALL AND CEILING FINISHES, OR THERE IS NO ACCESS THROUGH AN ATTIC, BASEMENT OR CRAWL SPACE. (CRC R315.1)

5. A 72" HIGH NON-ABSORBENT WALL SURFACE IN BATHTUB AND SHOWER COMPARTMENTS. (CRC R307.2)

6. ALL NEW WINDOWS AND GLAZED DOORS DUAL GLAZED SLIDERS.

7. GLAZING IN DOORS AND WINDOWS SHALL BE TEMPERED (CRC R308.4):

A) IN OPERABLE PANELS OF DOORS
B) WITHIN 24" OF A DOOR WHEN BOTTOM EDGE IS LESS THAN 60" ABOVE WALKING SURFACE.
THE BOTTOM

C) IN AN INDIVIDUAL PANE LARGER THAN 9 SQ. FT. WHEN THE BOTTOM EDGE IS WITHIN 18" OF THE FLOOR, WHEN THE TOP EDGE IS MORE THAN 36" ABOVE THE FLOOR, AND WHEN WITHIN 36" ABOVE THE FLOOR, AND WHEN WITHIN 36" OF A WALKING SURFACE AS MEASURED HORIZONTALLY AND IN STRAIGHT LINE,

D) IN RAILINGS.

E) GLAZING LOCATED

F) WITHIN 60" OF TUB OR SHOWER FLOOR.

G) GLAZING ADJACENT TO STAIRWAYS, LANDINGS AND RAMPS WITHIN 36" OF A WALKING SURFACE WHEN LESS THAN 60" ABOVE THE ADJACENT WALKING SURFACE

H) WITHIN 60" OF STAIRS AND STAIR LANDINGS

8. PROVIDE ELECTRICAL RECEPTACLES SO THAT NO POINT ALONG THE FLOOR LINE IN ANY WALL SPACE 2 FEET OR MORE IN WIDTH IS MORE THAN 6 FEET FROM AN OUTLET. FINED GLAZED PANELS IN EXTERIOR WALLS ARE CONSIDERED TO BE ALL SPACE. ARTICLE 210-52(a)

9. WATER HEATER TO BE STRAPPED TO WALL. (LATERAL STRAPS ARE REQUIRED.) UPC 511 MIN. 50 SQ. IN. VENT TOP & BOTTOM FOR EACH HEATER WITH A 24" INCHES CLEAR DOOR. T&P VALVE PIPED TO THE EXTERIOR.

10. LOW CONSUMPTION WATER CLOSET FOR NEW CONSTRUCTION. MAX. 1.6 GALLONS/FLUSH FOR ALL THE WATER CLOSETS.

11. BATHROOMS, WATER CLOSET COMPARTMENTS LAUNDRY ROOMS SHALL BE PROVIDED WITH NATURAL VENTILATION BY MEANS OF OPEN ABLE EXTERIOR OPENINGS WITH AN AREA NOT LESS THAN 1/20 OF THE FLOOR OF SUCH ROOMS WITH A MIN. 1.5 SQ. FR. OR PROVIDE A MECHANICAL VENTILATING SYSTEM WITH MINIMUM FIVE AIR CHANGES PER HOUR DIRECTLY TO THE OUTSIDE.

12. TEMPORARY TOILET FACILITIES TO BE PROVIDED.

13. UNDER FLOOR VENTILATION OPENING SIZE AND LOCATIONS EQUAL TO 1SQ.FR. OF UNDER FLOOR AREA. OPENINGS BE AS CLOSE TO CORNERS AS PRACTICAL AND SHALL PROVIDE CROSS VENTILATION ALONG THE LENGTH OF AT LEAST TWO OPPOSITE SIDES. OPENINGS SHALL HAVE 3/4" INCH CORROSION RESISTANT METAL MESH COVERING.

14. THE REQUIRED ATTIC VENTILATING AREA RATIO IS 1/150 OF ATTIC AREA OR 1/300 OF ATTIC AREA IF AT LEAST HALF OF THE VENT AREA IS PROVIDED BY VENTILATORS LOCATED IN THE UPPER PORTION OF THE SPACE TO BE VENTILATED AT LEAST 3'-0" ABOVE EAVE OR CORNICE VENTS. OPENINGS TO HAVE 1/4" INCH CORROSION RESISTANT METAL MESH COVERING.

15. A MINIMUM 4" EXHAUST DUCT MUST BE PROVIDED. (CMC 504.3.2) A FLEXIBLE DUCT CANNOT EXTEND MORE THAN 6FT. AND CANNOT BE CONCEALED (CMC 504.3.2) DRYER EXHAUST CANNOT EXCEED 14 FT. WITH MAX. OF TWO 90 ELBOWS. (CMC 504.3.2). EXHAUST TO OUTDOORS.

16. A MINIMUM OF 24 INCHES CLEAR IN FRONT OF WATER CLOSET, AND A MINIMUM COMPARTMENT WIDTH OF 30 INCHES (CPC 407.5)

17. VENTS AND FOUNDATION OPENINGS.

ATTIC VENTILATION, FOUNDATION AND UNDERFLOOR VENTS OR OTHER VENTILATION OPENINGS IN VERTICAL EXTERIOR WALLS, VENTS THROUGH ROOFS, AND VENTS SHALL NOT EXCEED 144 SQ. INCH EACH. VENTS SHALL BE COVERED WITH NONCOMBUSTIBLE, CORROSION-RESISTANT MESH WITH OPENINGS NOT EXCEEDING 1/4 INCH. ATTIC VENTILATION OPENINGS SHALL NOT BE LOCATED IN SOFFITS, IN EAVE OVERHANGS, BETWEEN RAFTERS AT EAVES, OR IN OTHER OVERHANG AREAS. GABLE END AND DORMER VENTS SHALL BE LOCATED AT LEAST 10 FEET FROM THE PROPERTY LINES. UNDERFLOOR VENTILATION OPENINGS SHALL BE LOCATED AS CLOSE TO THE FLOOR AS POSSIBLE.

18. "THE CONSTRUCTION SHALL NOT RESTRICT FIVE-FOOT CLEAR AND UNOBSTRUCTED ACCESS TO ANY WATER OR POWER DISTRIBUTION FACILITIES (POWER POLES, PULL-BOXES, TRANSFORMERS, VAULTS, PUMPS, VALVES, METERS, APPURTENANCES, ETC.) OR TO THE LOCATION OF THE HOOK-UP. THE CONSTRUCTION SHALL NOT BE WITHIN TEN FEET OF ANY POWER LINES--WHEATHER OR NOT THE LINES ARE LOCATED ON THE PROPERTY. FAILURE TO COMPLY MAY CAUSE CONSTRUCTION DELAYS AND/OR ADDITIONAL EXPENSES."

19. FIRE DEPARTMENT NOTE:

PROVIDE A COMPLETE AUTOMATIC FIRE SPRINKLER SYSTEM THROUGHOUT THE STRUCTURE INSTALLED IN ACCORDANCE WITH THE RECOMMENDATIONS OF N.F.P.A. 13D AND THE REQUIREMENTS OF THE BURBANK FIRE DEPARTMENT. FIRE SPRINKLER PLANS SHALL BE SUBMITTED WITHIN 30 DAYS OF ISSUANCE OF BUILDING PERMIT. A SEPARATE PERMIT IS REQUIRED ALL SPRINKLER PIPING SHALL BE CONCEALED: NO EXPOSED PIPING ON EXTERIOR PERMITTED. RISER SHALL BE CONCEALED.

FOR QUESTIONS ABOUT FIRE REQUIREMENTS CALL FIRE DEPT. AT (818) 238-3473

20. PROVIDE AUDIBILITY THROUGHOUT THE STRUCTURE IN THE EVENT OF ACTIVATION OF THE AUTOMATIC FIRE SPRINKLER CAREFUL ATTENTION TO AESTHETICS SHALL BE TAKEN INTO CONSIDERATION. IF DEVICES WILL BE INSTALLED INSIDE THE HOUSE AND VISIBLE TO OCCUPANTS, THEY SHALL BE ARCHITECTURAL GRADE MINI-HIRNS OR EQUIVALENT WITH ARCHITECTURAL FINISH.

OTHERWISE, STANDARD HORN OR BELL TYPE DEVICES MAY BE USED IF INSTALLED OUT OF VIEW(e.g.: closet or similar). EXTERIOR DEVICE IS NOT REQUIRED IF THE ALARM IS AUDIBLE FROM THE OUTSIDE. IF AN EXTERIOR DEVICE IS PROVIDED, IT SHALL BE INSTALLED IN AN AESTHETICALLY CHOSEN LOCATION AND SHALL BE NOMINALLY 4".

21. LIGHTING:

a. HIGH EFFICACY LUMINAIRES. A HIGH EFFICACY LUMINAIRE OR LED LIGHT ENOUGH WITH INTEGRAL HEAT SINK HAS AN EFFICACY NO LOWER THAN THAT SPECIFIED IN TABLE 150-C AND IS NOT LOW EFFICACY AS SPECIFIED BY SECTION 150(k)2. A LOW EFFICACY LUMNAIRE TYPICALLY CONTAINS A MEDIUM SCREW BASE SOCKET (E24/E26) OR OTHER LINE-VOLTAGE LAMP HOLDER.

EXCEPTION: HIGH INTENSITY DISCHARGE (HID) LUMINAIRES WITH A FACTORY INSTALLED BALLAST AND HID RATED MEDIUM SCREW-BASED SOCKETS PROVIDED THEY MEET THE EFFICACIES CONTAINED IN TABLE 150-C OR A LUMINAIRE WITH A FACTORY INSTALLED GU-24 LAMP HOLDER IF IT MEETS THE REQUIREMENTS OF 150(k)2A

22. LUMINAIRE WATTAGE. THE WATTAGE OF PERMANENTLY INSTALLED LUMINAIRES SHALL BE DETERMINED AS SPECIFIED BY SECTION 130(d). IN RESIDENTIAL KITCHENS,THE WATTAGE OF ELECTRICAL BOXES FINISHED WITH A BLANK COVER OR WHERE THE BOX CAN BE USED FOR A LUMINAIRE OR CEILING FAN IS 180 WATTS OF LOW EFFICACY PER BOX. [SECTION 150(k)3]

23. LIGHTING IN KITCHENS. A MINIMUM OF 50% OF THE TOTAL RATED WATTAGE OF PERMANENTLY INSTALLED LUMINAIRES IN KITCHENS SHALL BE HIGH EFFICACY. KITCHEN LIGHTING INCLUDES ALL PERMANENTLY INSTALLED LIGHTING IN THE KITCHEN EXCEPT FOR LIGHT THAT IS INTERNAL TO THE CABINETS. NOTE: LIGHTING IN AREAS ADJACENT TO THE KITCHEN, INCLUDING BUT NOT LIMITED TO DINING AND NOOK AREAS, ARE CONSIDERED KITCHEN LIGHTING IF THEY ARE NOT SEPARATELY SWITCHED FROM KITCHEN LIGHTING. [SECTION 150(k)8]

EXCEPTION: UP TO 50 WATTS FOR DWELLINGS LESS THAN OR EQUAL TO 2500 S.F. OR 100 WATTS FOR DWELLINGS LARGER THAN 2500 S.F. MAY BE EXEMPT FROM THE 50% RULE PROVIDED THAT ALL LOW EFFICACY LUMINAIRES IN THE KITCHEN ARE CONTROLLED BY A MANUAL-ON OCCUPANT SENSOR OR DIMMER, AND ALL PERMANENTLY INSTALLED LUMINAIRES IN THE GARAGE, LAUNDRY ROOM, CLOSETS GREATER THAN 70 S.F. AND UTILITY ROOMS ARE HIGH EFFICACY AND CONTROLLED BY AN MANUAL-ON OCCUPANT SENSOR.

24. LIGHTING IN BATHROOM, GARAGES, LAUNDRY ROOMS, CLOSETS AND UTILITY ROOMS.

PERMANENTLY INSTALLED LUMINAIRES IN BATHROOMS, GARAGES, LAUNDRY ROOMS, CLOSETS AND UTILITY ROOMS SHALL BE HIGH EFFICACY LUMINAIRES. [SECTION 150(k) 10]

EXCEPTION 1: PERMANENTLY INSTALLED LOW EFFICACY LUMINAIRES SHALL BE ALLOWED PROVIDED THAT THEY ARE CONTROLLED BY AN OCCUPANT SENSOR CERTIFIED TO COMPLY WITH SECTION 119.
EXCEPTION 2: PERMANENTLY INSTALLED LOW EFFICACY LUMINAIRES IN CLOSETS LESS THAN 70 S.F. ARE REQUIRED TO BE CONTROLLED BY AN OCCUPANT SENSOR.

25. LIGHTING OTHER THAN IN KITCHENS, BATHROOMS, GARAGES, LAUNDRY ROOMS, CLOSETS AND UTILITY ROOMS.

PERMANENTLY INSTALLED LUMINAIRES LOCATED OTHER THAN IN KITCHENS, BATHROOMS, GARAGES, LAUNDRY ROOMS, AND UTILITY ROOMS SHALL BE HIGH EFFICACY LUMINAIRES. [SECTION 150(k) 10]

EXCEPTION 1: PERMANENTLY INSTALLED LOW EFFICACY LUMINAIRES SHALL BE ALLOWED PROVIDED THAT THEY ARE CONTROLLED BY A DIMMER SWITCH OR A MANUAL-ON OCCUPANT SENSOR THAT COMPLIES WITH SECTION 119.
EXCEPTION 2: LIGHTING IN DETACHED STORAGE BUILDINGS LESS THAN 1,000 SQUARE FEET ON A RESIDENTIAL SITE.


26. OUTDOOR LIGHTING.

LUMINAIRES PROVIDING OUTDOOR LIGHTING AND PERMANENTLY MOUNTED TO A RESIDENTIAL BUILDING OR TO OTHER BUILDINGS ON THE SAME LOT SHALL BE HIGH EFFICACY LUMINAIRES. [SECTION 150(k)13]

EXCEPTION 1: PERMANENTLY INSTALLED OUTDOOR LUMINAIRES THAT ARE NOT HIGH EFFICACY SHALL BE ALLOWED PROVIDED THAT THEY ARE CONTROLLED BY A MANUAL ON-OFF, A MOTION SENSOR NOT HAVING AN OVERRIDE SWITCH, AND ONE OF THE FOLLOWING THAT DO NOT HAVE AN OVERRIDE SWITCH: AN INTEGRAL PHOTOCONTROL, ASTRONOMICAL TIME CLOCK, OR ENERGY MANAGEMENT CONTROL SYSTEM (EMCS).
EXCEPTION 2: OUTDOOR LUMINAIRES MAY BE CONTROLLED BY A TEMPORARY OVERRIDE PROVIDED THE MOTION SENSING FUNCTION IS AUTOMATICALLY REACTIVATED WITHIN 6 HOURS.
EXCEPTION 3: PERMANENTLY INSTALLED LUMINAIRES IN OR AROUND SWIMMING POOLS, WATER FEATURES, OR OTHER LOCATIONS SUBJECT TO ARTICLE 680 OF THE CALIFORNIA ELECTRIC CODE NEED NOT BE HIGH EFFICACY LUMINAIRES.

27. THE BUILDING SHALL BE EQUIPPED WITH AN AUTOMATIC RESIDENTIAL FIRE SPRINKLER SYSTEM IN ACCORDANCE WITH SECTION NFPA 13D. A SEPARATE PERMIT IS REQUIRED FROM THE BURBANK FIRE DEPT. FOR QUESTIONS ABOUT SPRINKLER REQUIREMENTS, CALL THE FIRE DEPT. @ 818-238-3473.

28. THE SPRINKLER SYSTEM SHALL BE APPROVED BY FIRE DEPARTMENT PRIOR INSTALLATION.

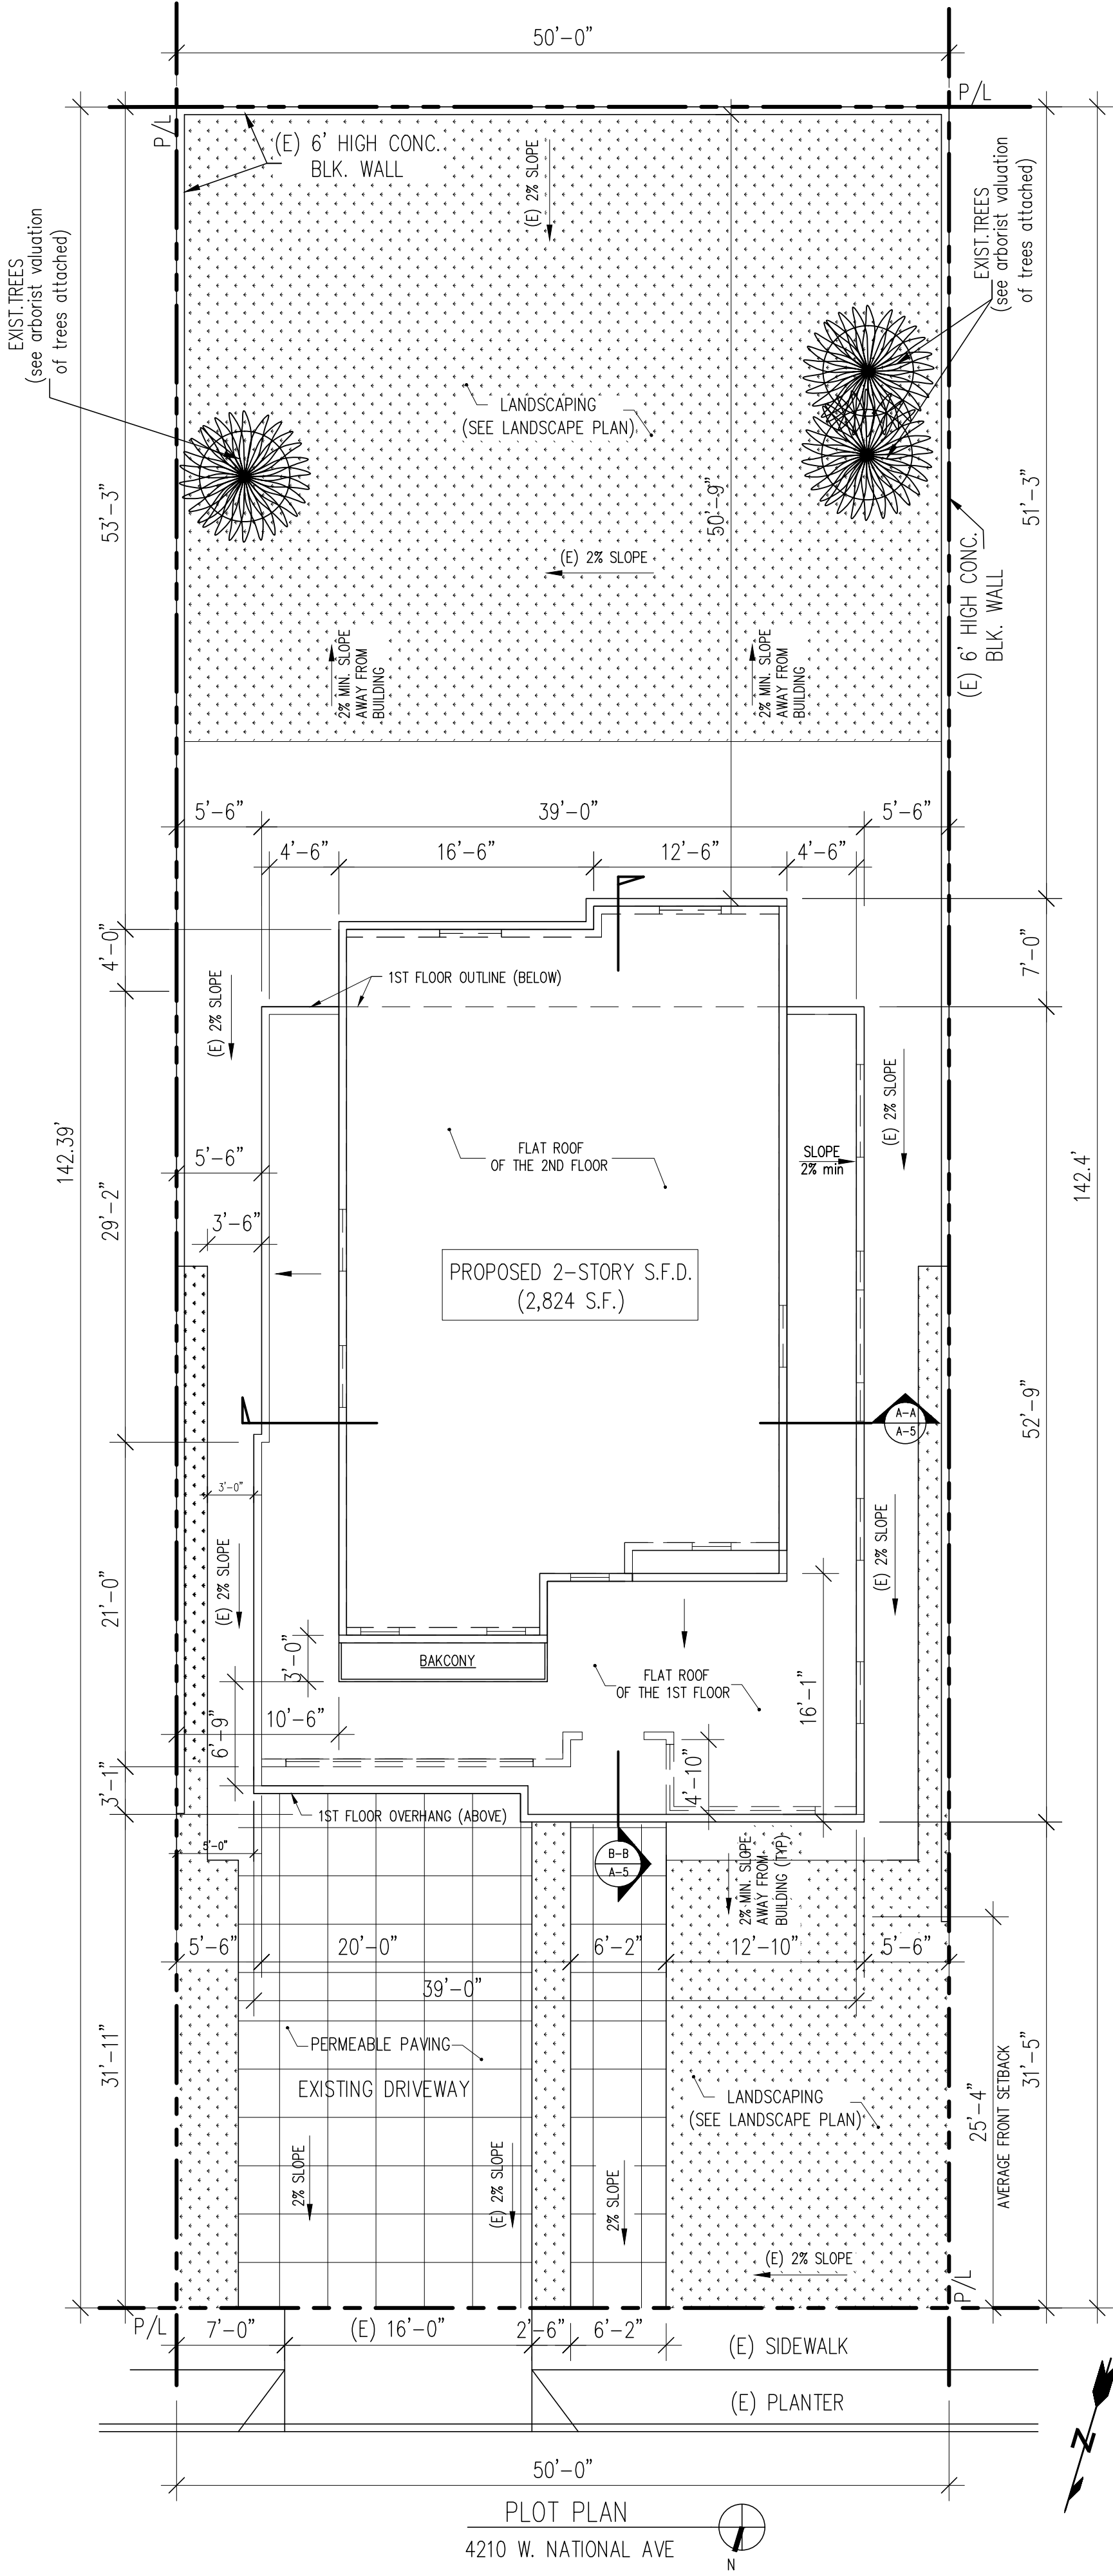

SETBACK CERTIFICATION REQUIREMENT

A CALIFORNIA STATE LICENSED SURVEYOR IS REQUIRED TO CERTIFY THE LOCATION AND SETBACKS OF ALL NEW CONSTRUCTION PRIOR TO THE FIRST FOUNDATION INSPECTION. A COPY OF THE CERTIFICATION SHALL BE AVAILABLE TO THE BUILDING DIVISION INSPECTOR FOR THE JOB FILE PRIOR TO THE FIRST INSPECTION. (BMC 9-1-1-110.3.1.1)

PROJECT: (N) 2-STORY S.F.D. W/ ATTACHED 2-CAR GARAGE

ARCHITECT/DESIGNER: ART CONSTRUCTION SERVICES
144 S. First St., suite 201, Burbank, CA, 91502
TEL (818) 363-1160, FAX (818) 363-1160

ENGINEER: ~~~~~
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TEL (818) 363-1160, FAX (818) 363-1160

OWNER: HAIKAZ SARGISIAN
4210 W. NATIONAL AVE
BURBANK, CA. 91505
(424) 888-0909

JOB NO: ** **

SHEET TITLE


PLOT PLAN

NOT FOR CONST.
ISSUED FOR PERMIT
ISSUED FOR CONST.
DATE: 01-05-2021

SCALE: 1/8"=1'-0" U.N.O.

SHEET NO.

A-1

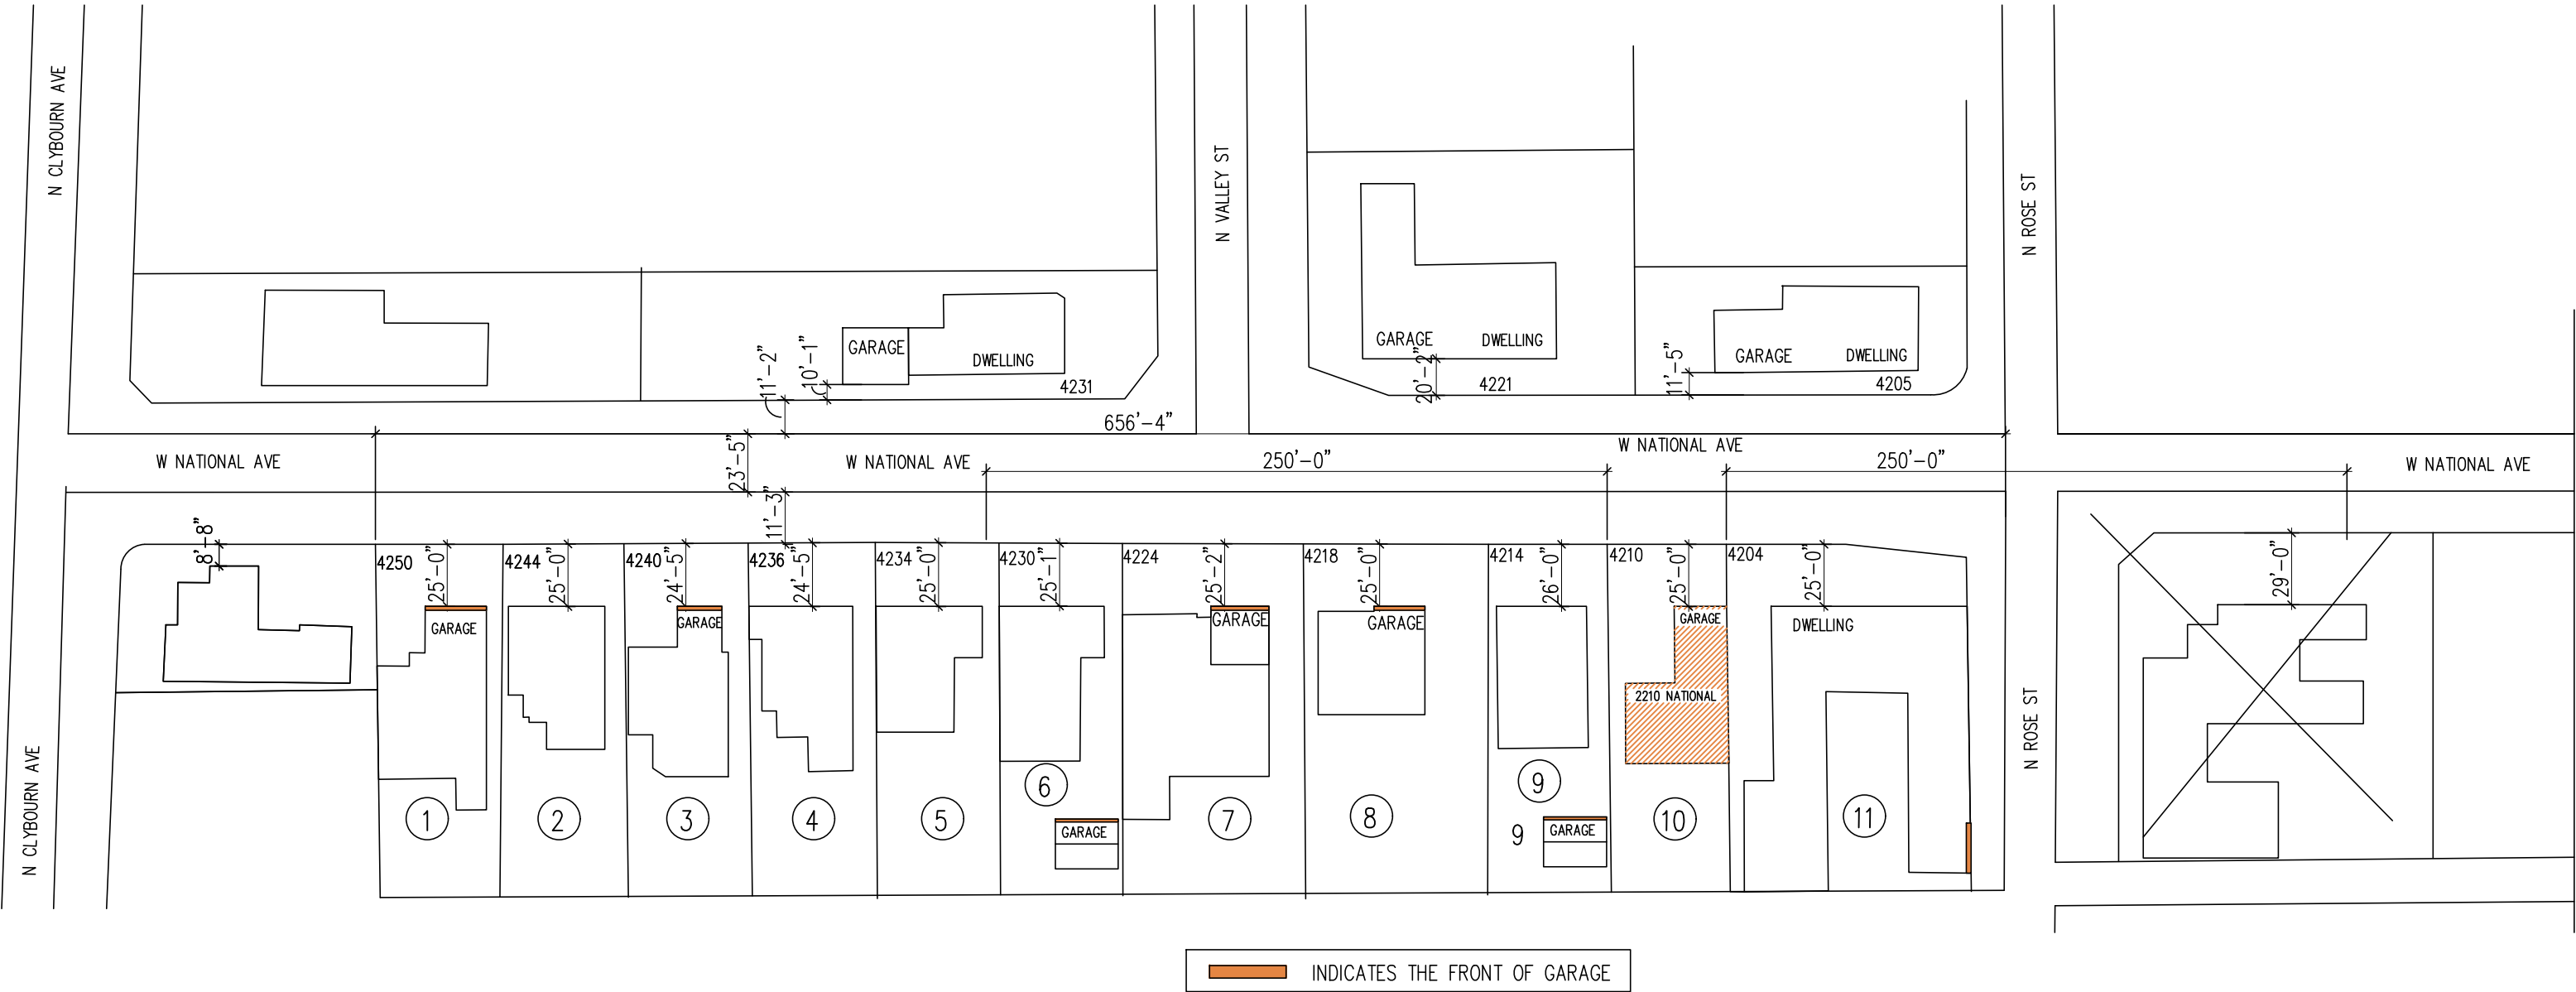

NOTES:
THE AVERAGE FRONT YARD SETBACK SHALL BE DETERMINED FROM LOTS ON THE SAME BLOCK THAT ARE WITHIN 250 FEET ON EITHER SIDE OF THE SUBJECT PROPERTY. IN CALCULATING THE AVERAGE SETBACKS, MEASUREMENTS THAT VARY FROM THE AVERAGE BY MORE THAN 150 PERCENT SHALL NOT BE USED TO CALCULATE THE AVERAGE.

GARAGES LOCATED AT THE FRONT OF THE MAIN DWELLING WITH A DOOR PARALLEL TO THE STREET MUST BE LOCATED NO CLOSER TO THE FRONT PROPERTY LINE THAN 10 FEET BACK FROM THE GROUND FLOOR FACADE.

EXISTING FRONT YARD SETBACKS (GARAGES FACING THE "NATIONAL" S.T.)

No	ADDRESS #	FRONT SETBACK (FEET)	GARAGE SITUATED 10' BACK FROM THE GROUND FL. FRONT WALL LINE. (YES/NO)
1	4250		NO
2	4244		YES
3	4240		NO
4	4236		YES
5	4234		YES
6	4230	25'-2"	YES
7	4224	25'-3"	NO
8	4218	25'	NO
9	4214	26'	YES
10	4210	-	SUBJECT PROPERTY
11	4204	25'	YES

40% OF EXISTING GARAGES (IN THE BLOCK FACING THE NATIONAL STREET) ARE NOT SITUATED 10' BACK FROM THE (E) BUILDINGS' GROUND FLOOR FRONT WALL LINE:

FRONT YARD AVERAGE SETBACK = 25.3 FT.

TOTAL NUMBER OF LOTS = 6
NO. OF LOTS USED = 5
SETBACK RANGE = 25.00-26.00 FT.
LOTS USED:


LOT	SETBACK
1	25'-1"
2	25'-2"
3	25'-0"
4	26'-0"
5	SUBJ. PROPERTY.
6	25'-0"

THE FRONT YARD AVERAGE SETBACK: 127.5 / 5 = 25.5'




VICINITY MAP

2485 11
SCALE 1" = 100'

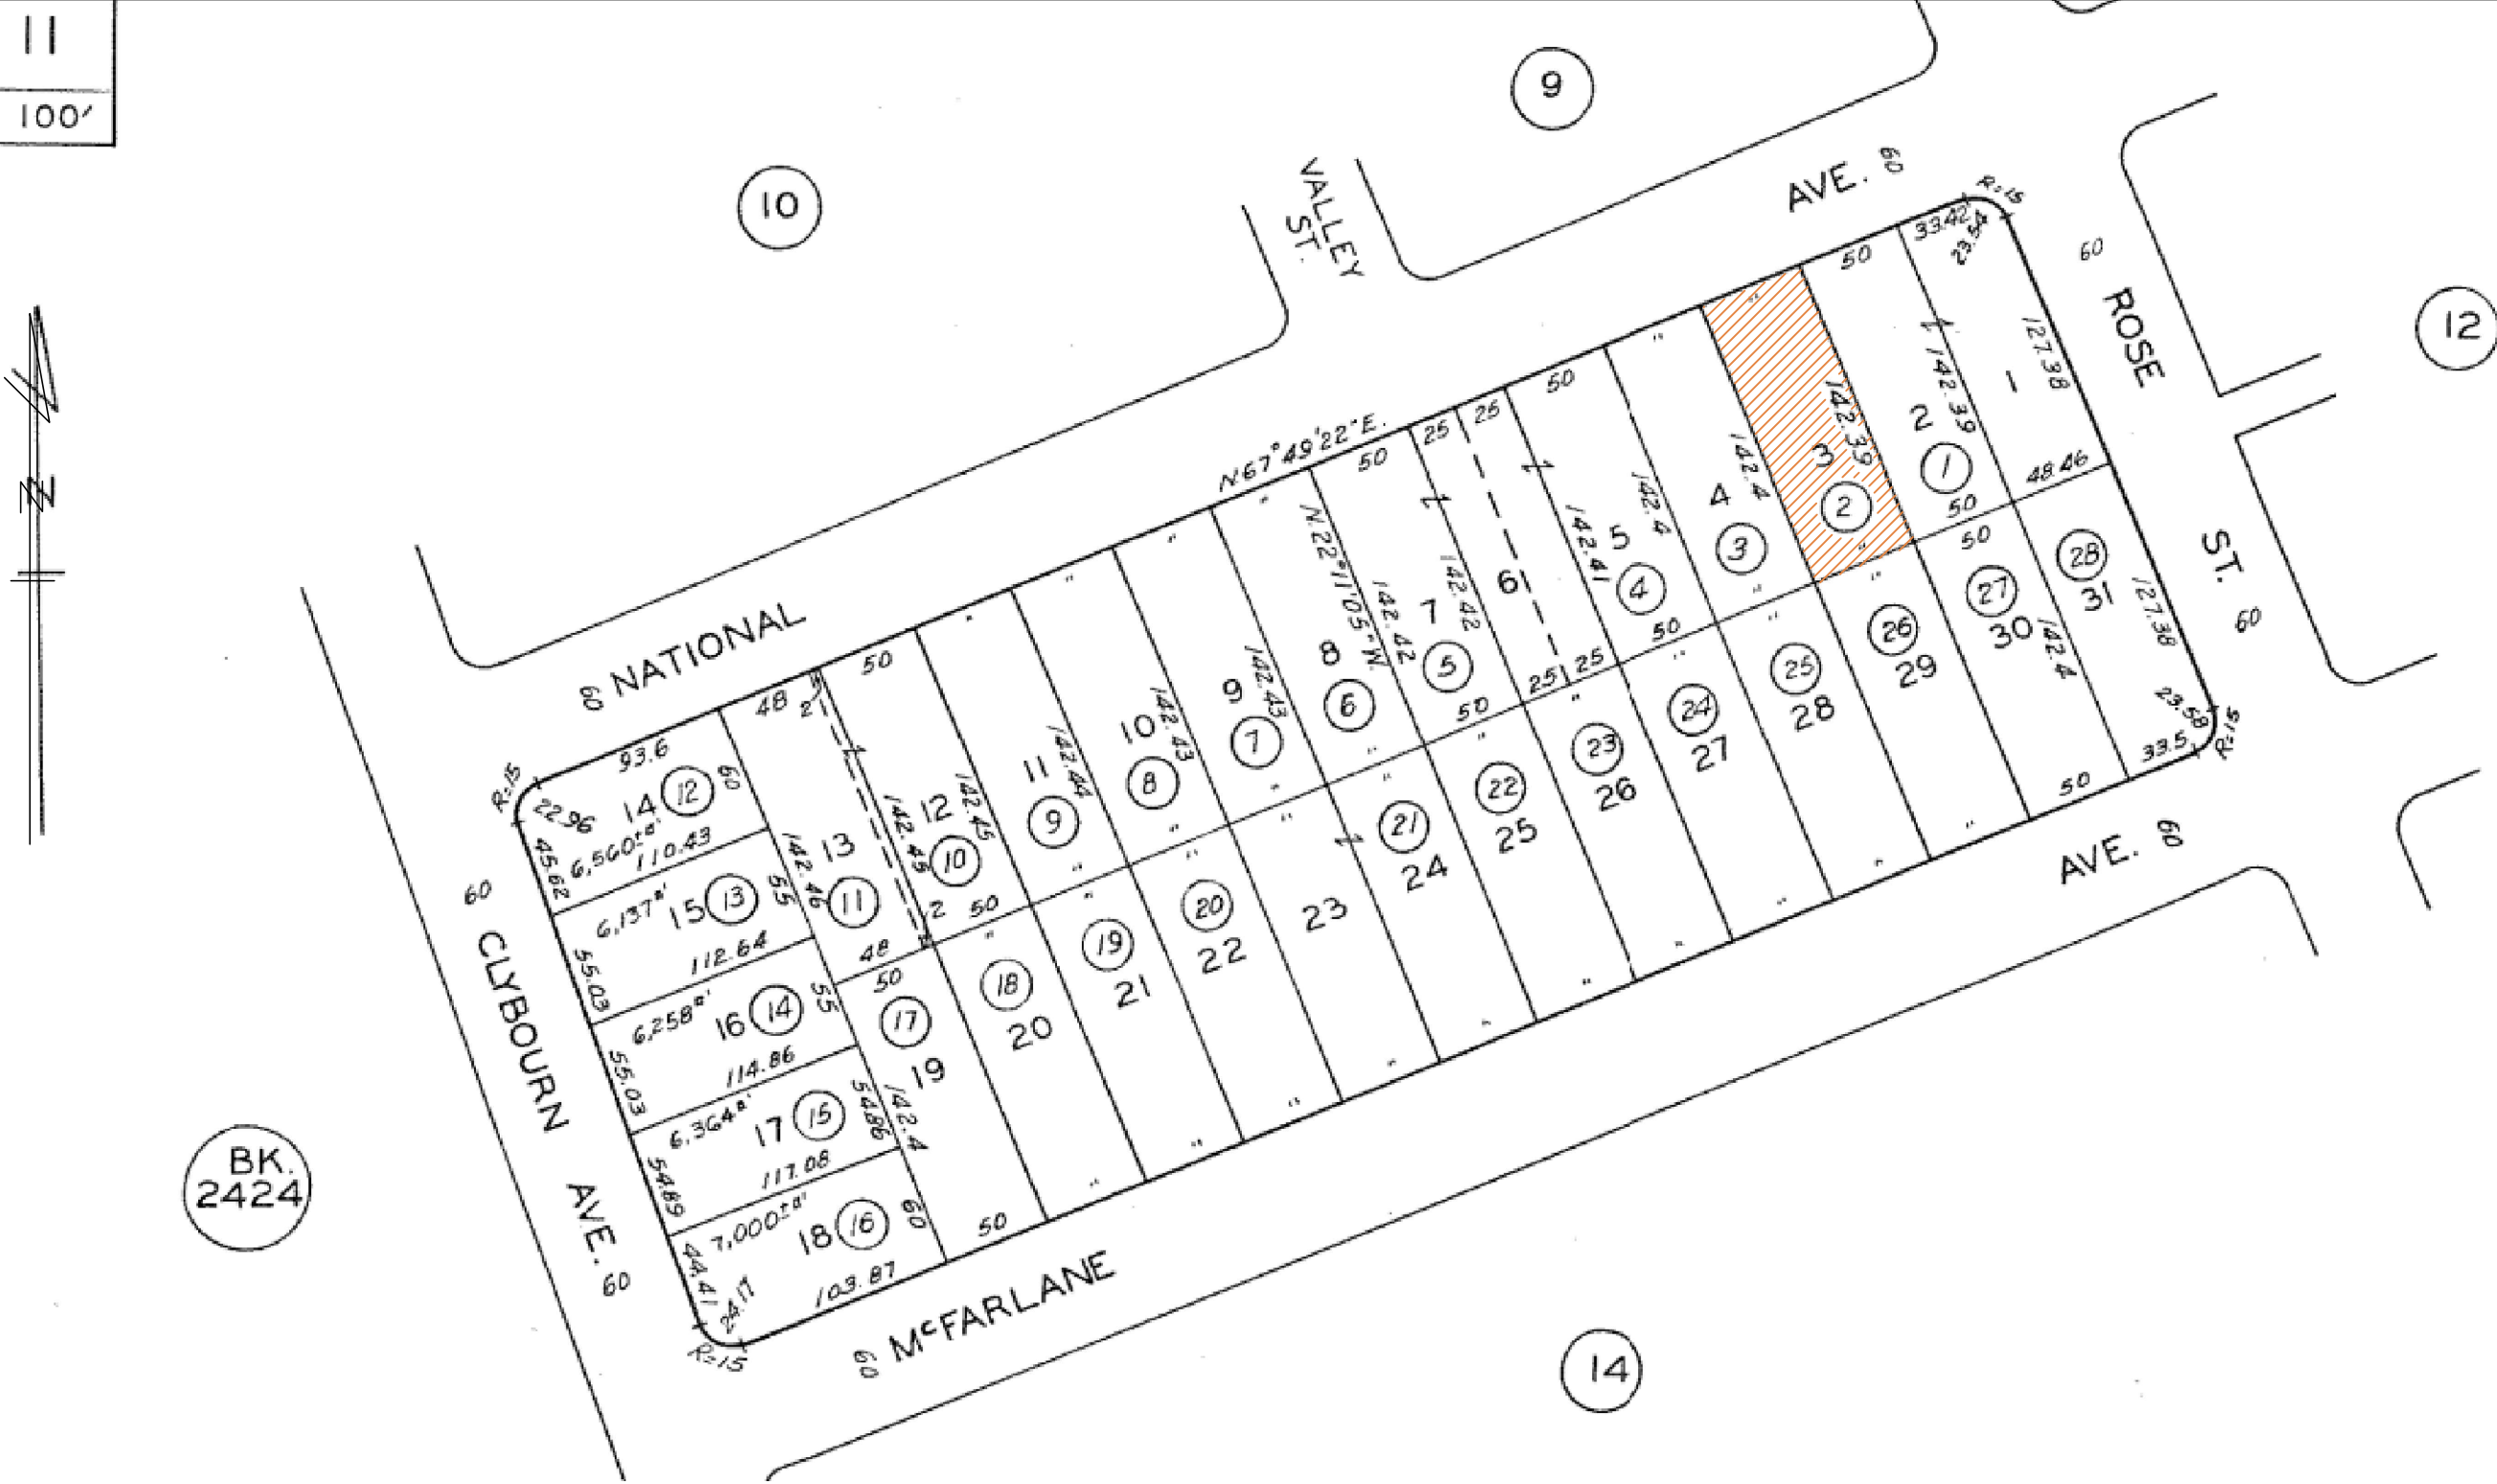

GOOGLE MAP

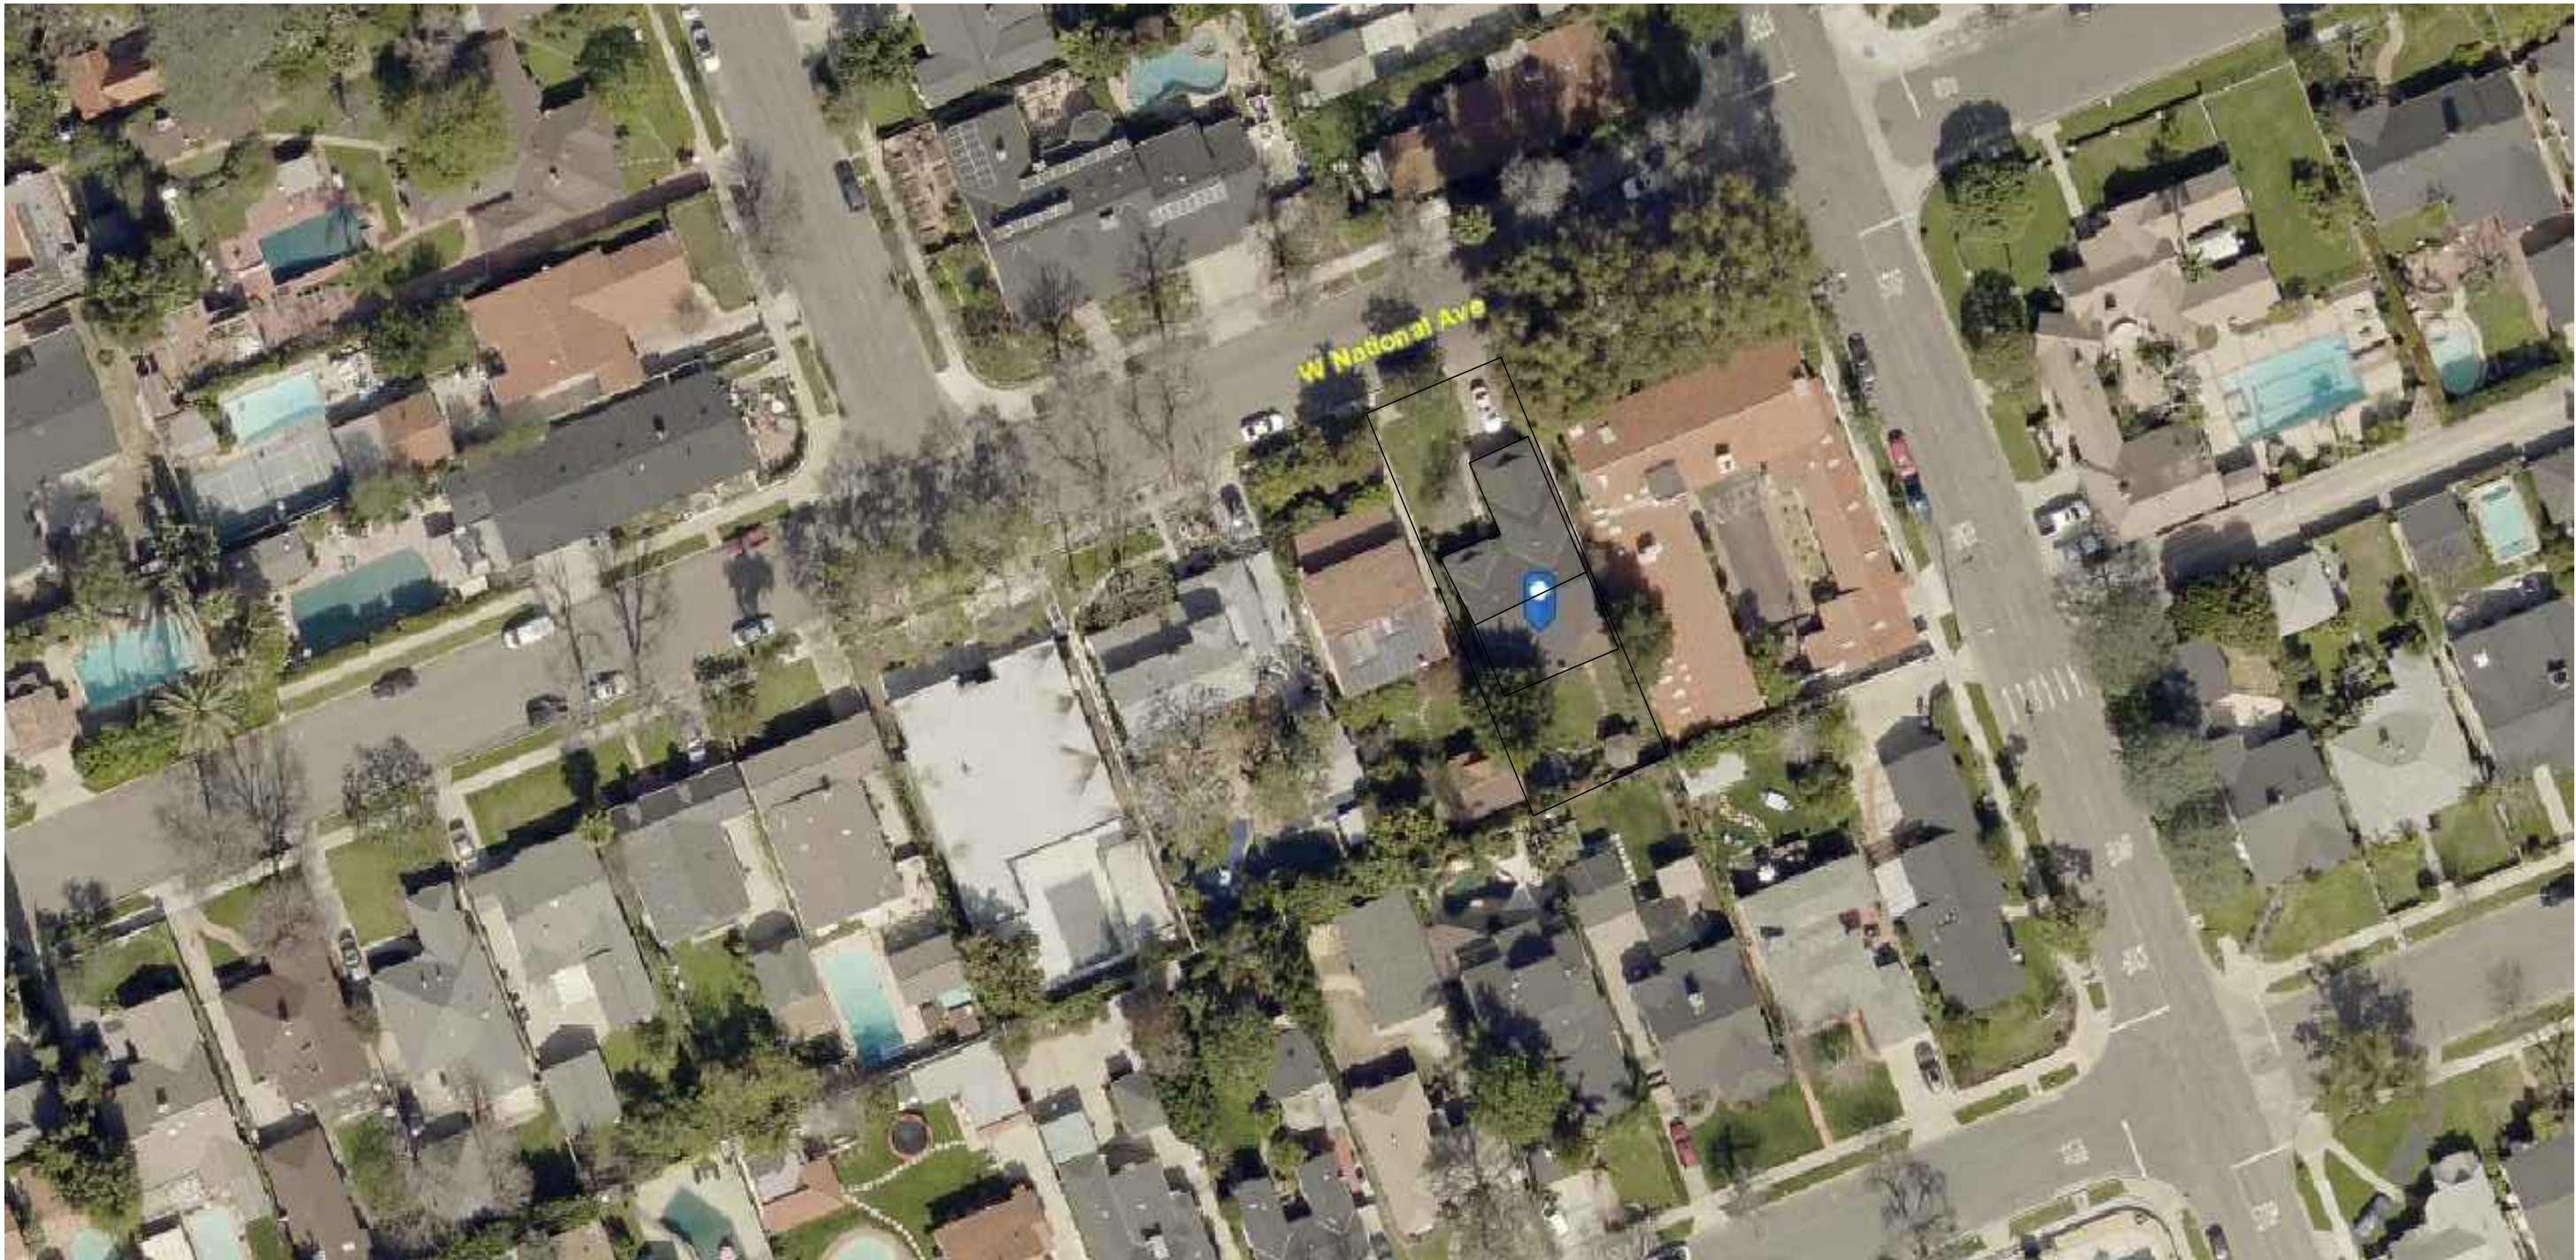

OWNER: HAIKAZ SARGISIAN
ADDRESS: 4210 W. NATIONAL AVE
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PROJECT: (N) 2-STORY S.F.D. W/ ATTACHED 2-CAR GARAGE
ADDRESS: 4210 W. NATIONAL AVE.
BURBANK, CA. 91505



JOB NO: **-**-**
SHEET TITLE

AVERAGE FRONT SETBACK CALC.

NOT FOR CONST.
ISSUED FOR PERMIT
ISSUED FOR CONST.
DATE: 01-05-2021

SCALE:
SHEET NO.

A-1a

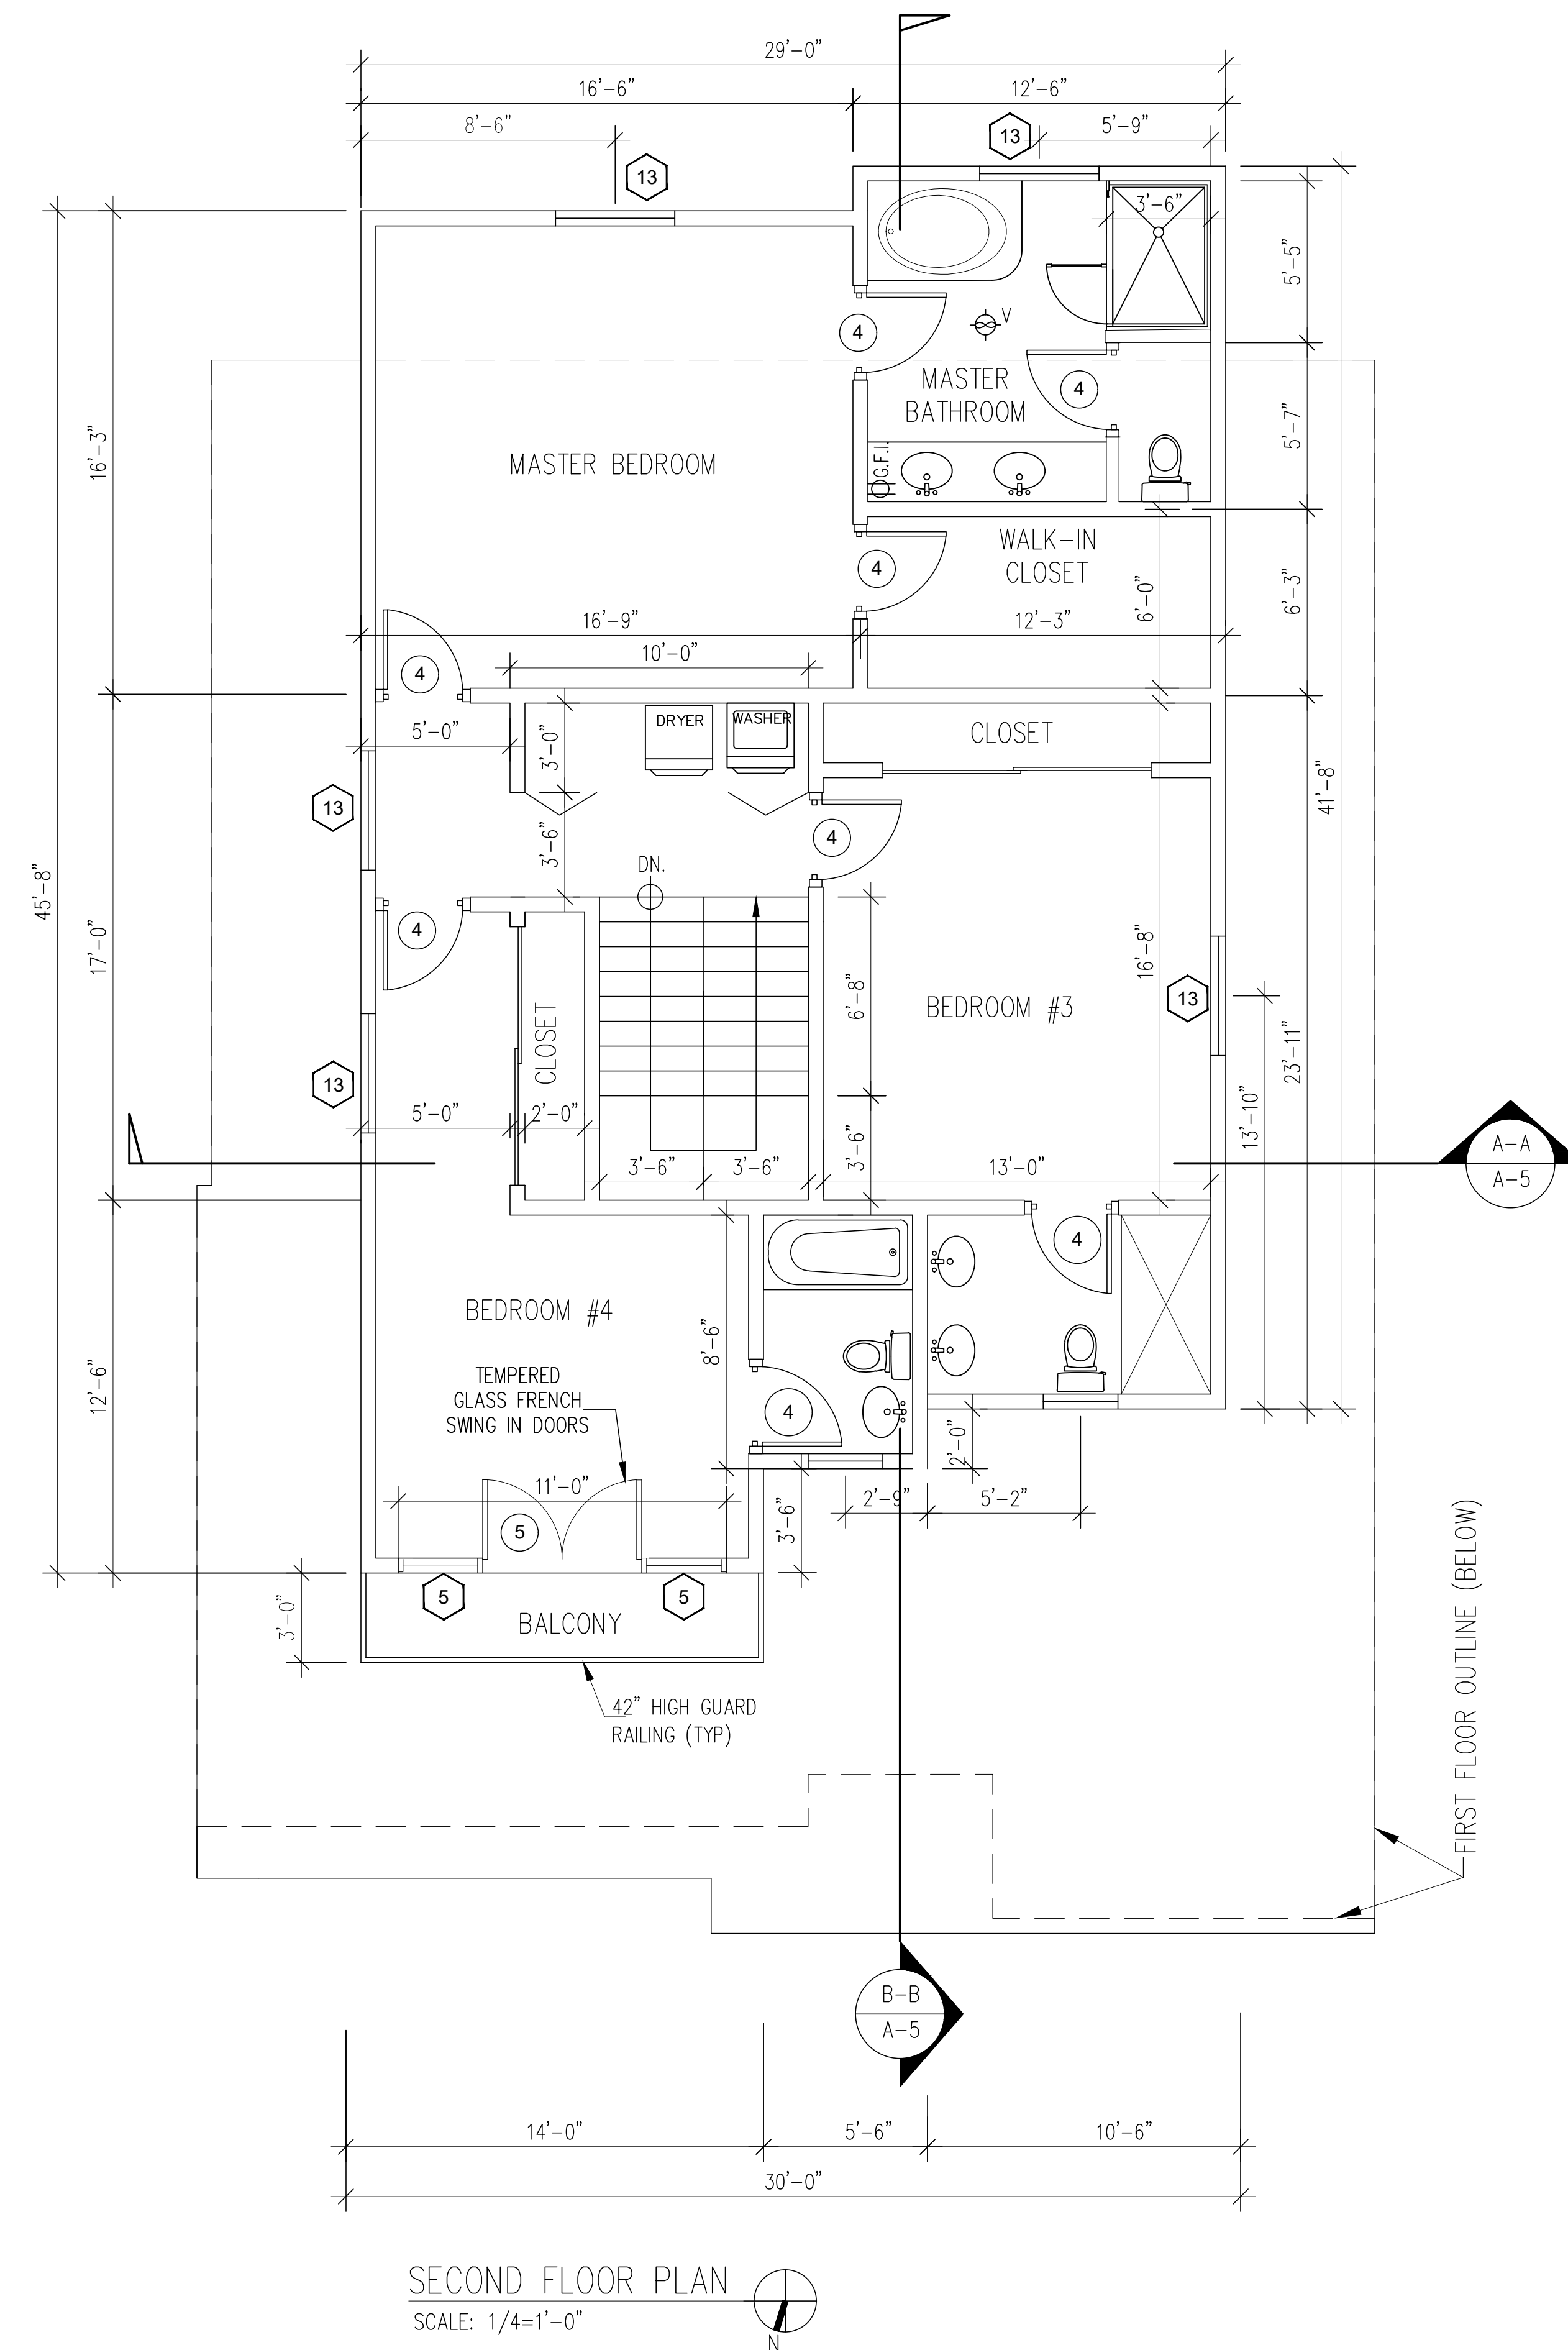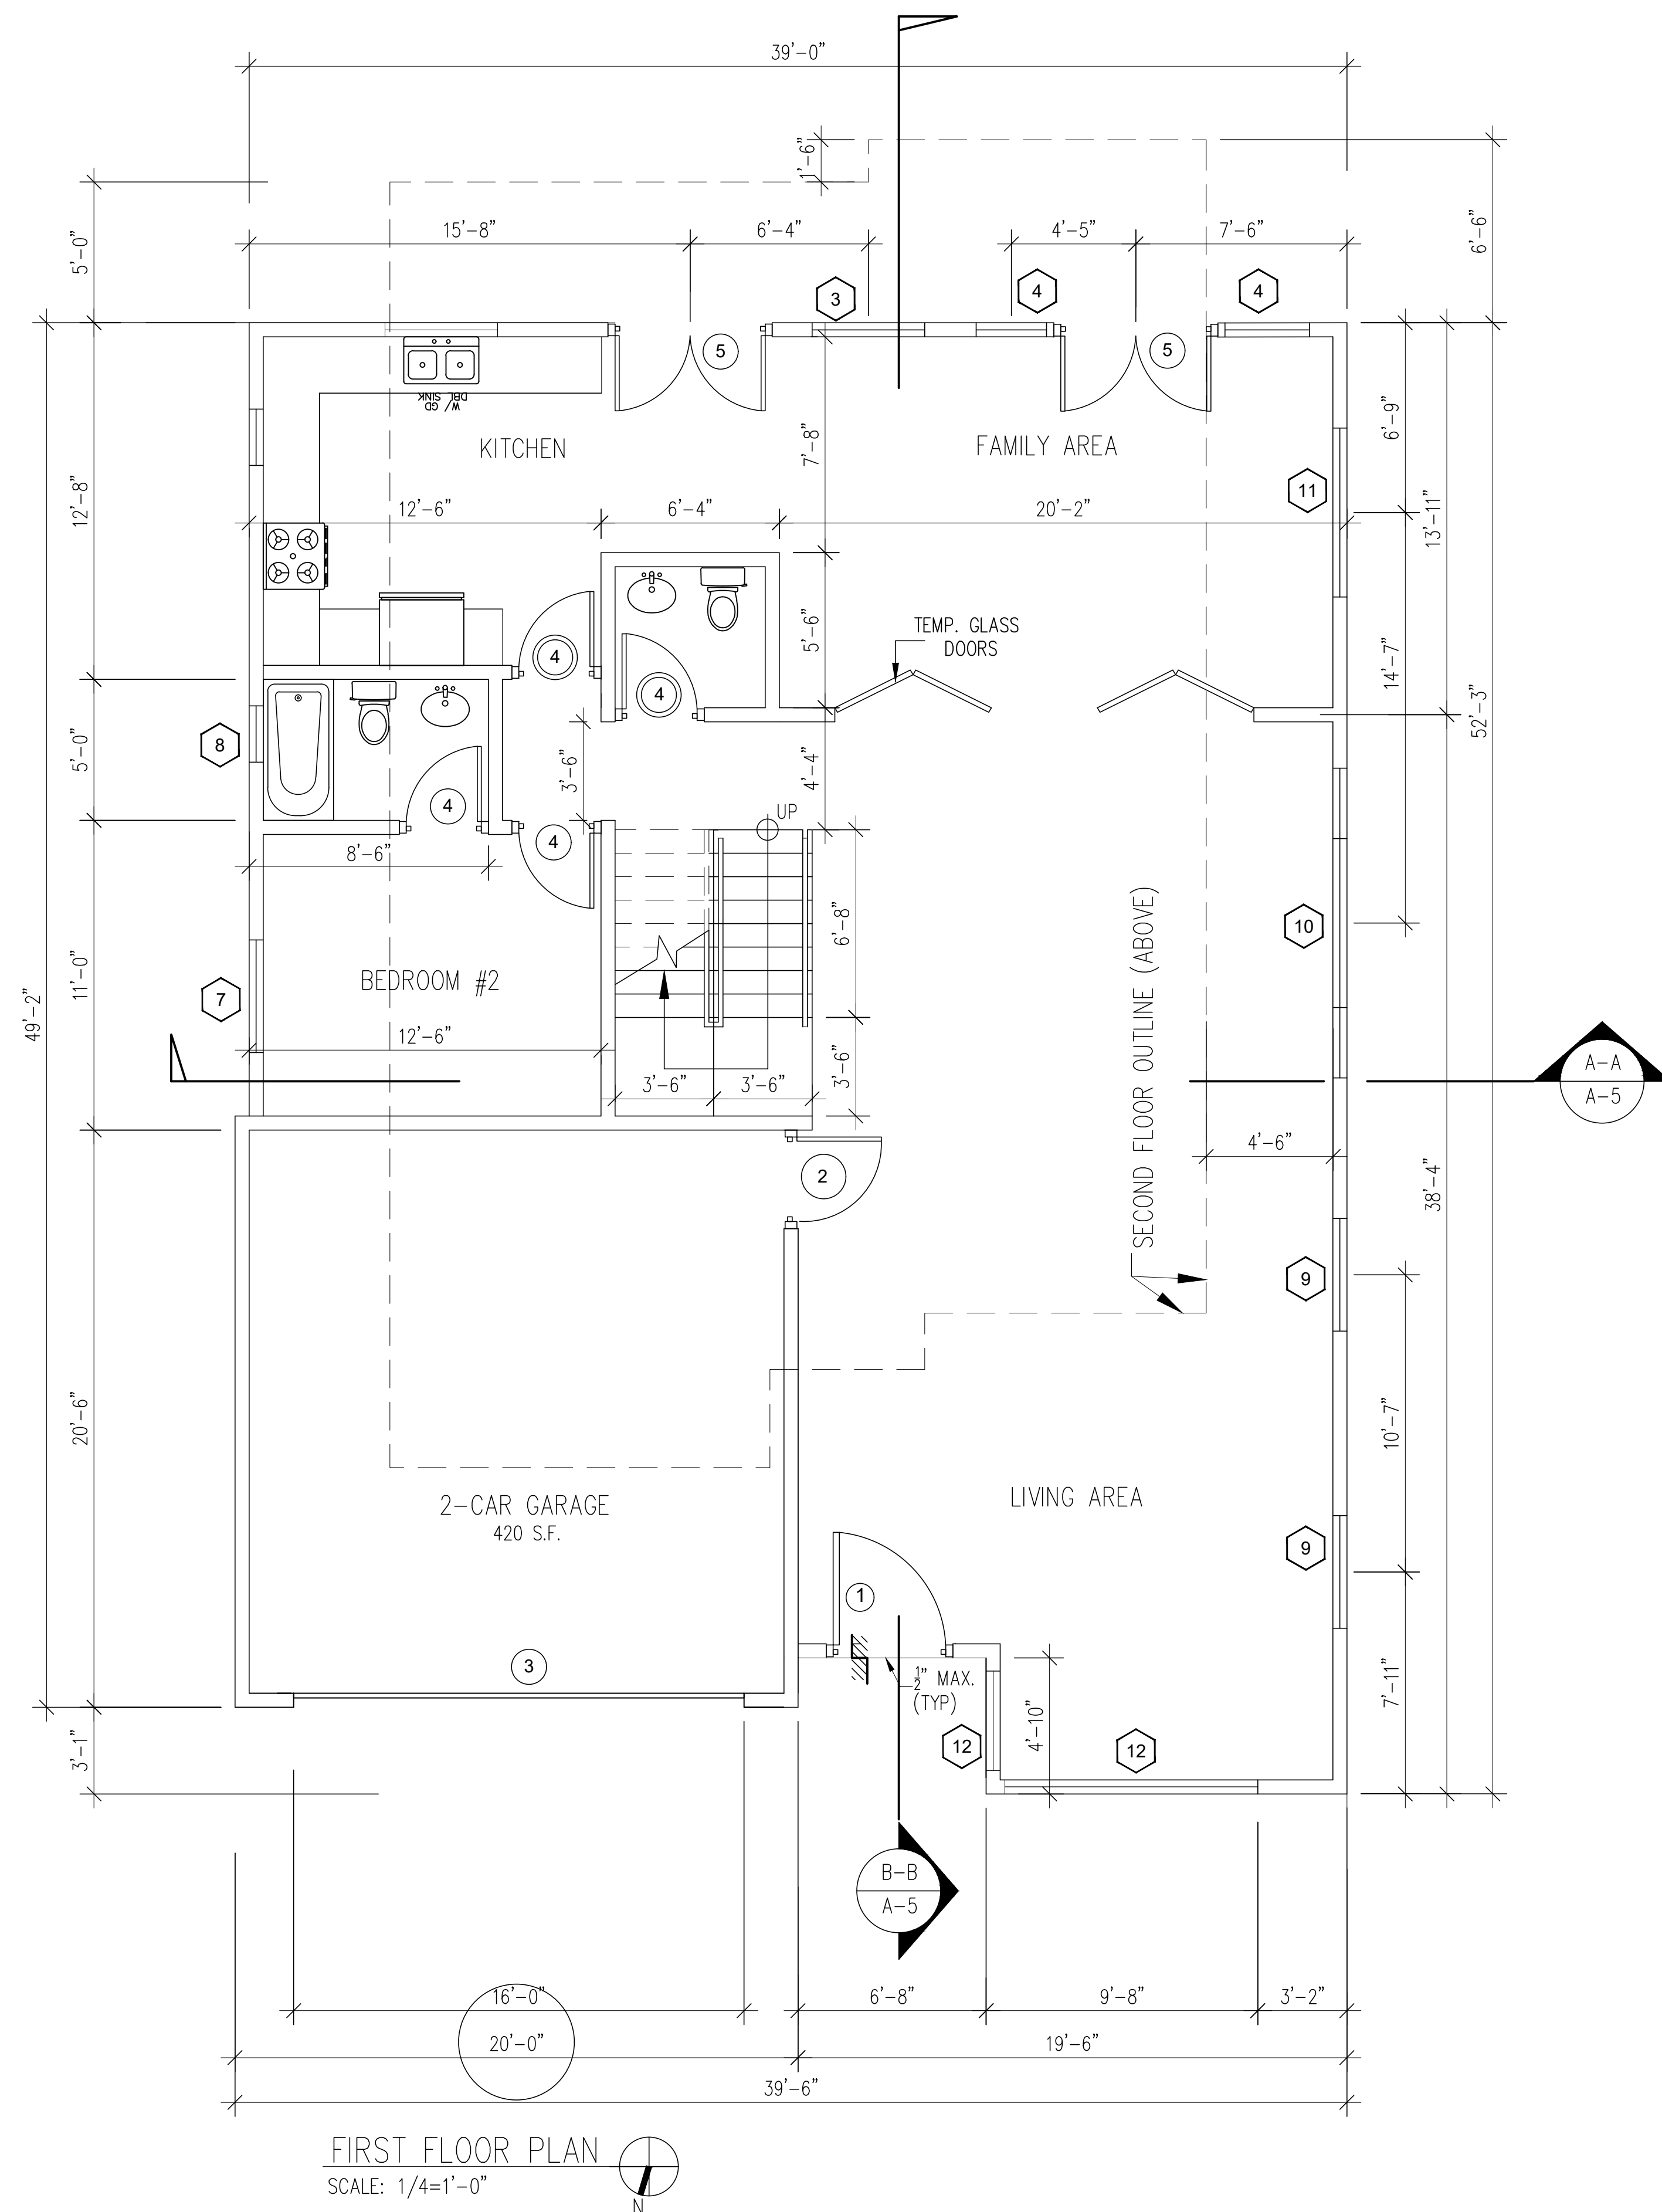

PROJECT:		(N) 2-STORY S.F.D. W/ ATTACHED 2-CAR GARAGE	
ADDRESS:		4210 W. NATIONAL AVE. DURBAN, CA. 94505	
JOB NO:		*** **	
SHEET TITLE		1ST FLOOR PLAN 2ND FLOOR PLAN	

	NOT FOR CONST.
	ISSUED FOR PERMIT
	ISSUED FOR CONST.
DATE: 01-05-2021	
SCALE: 1/4"=1'-0" U.N.O.	
SHEET NO.	

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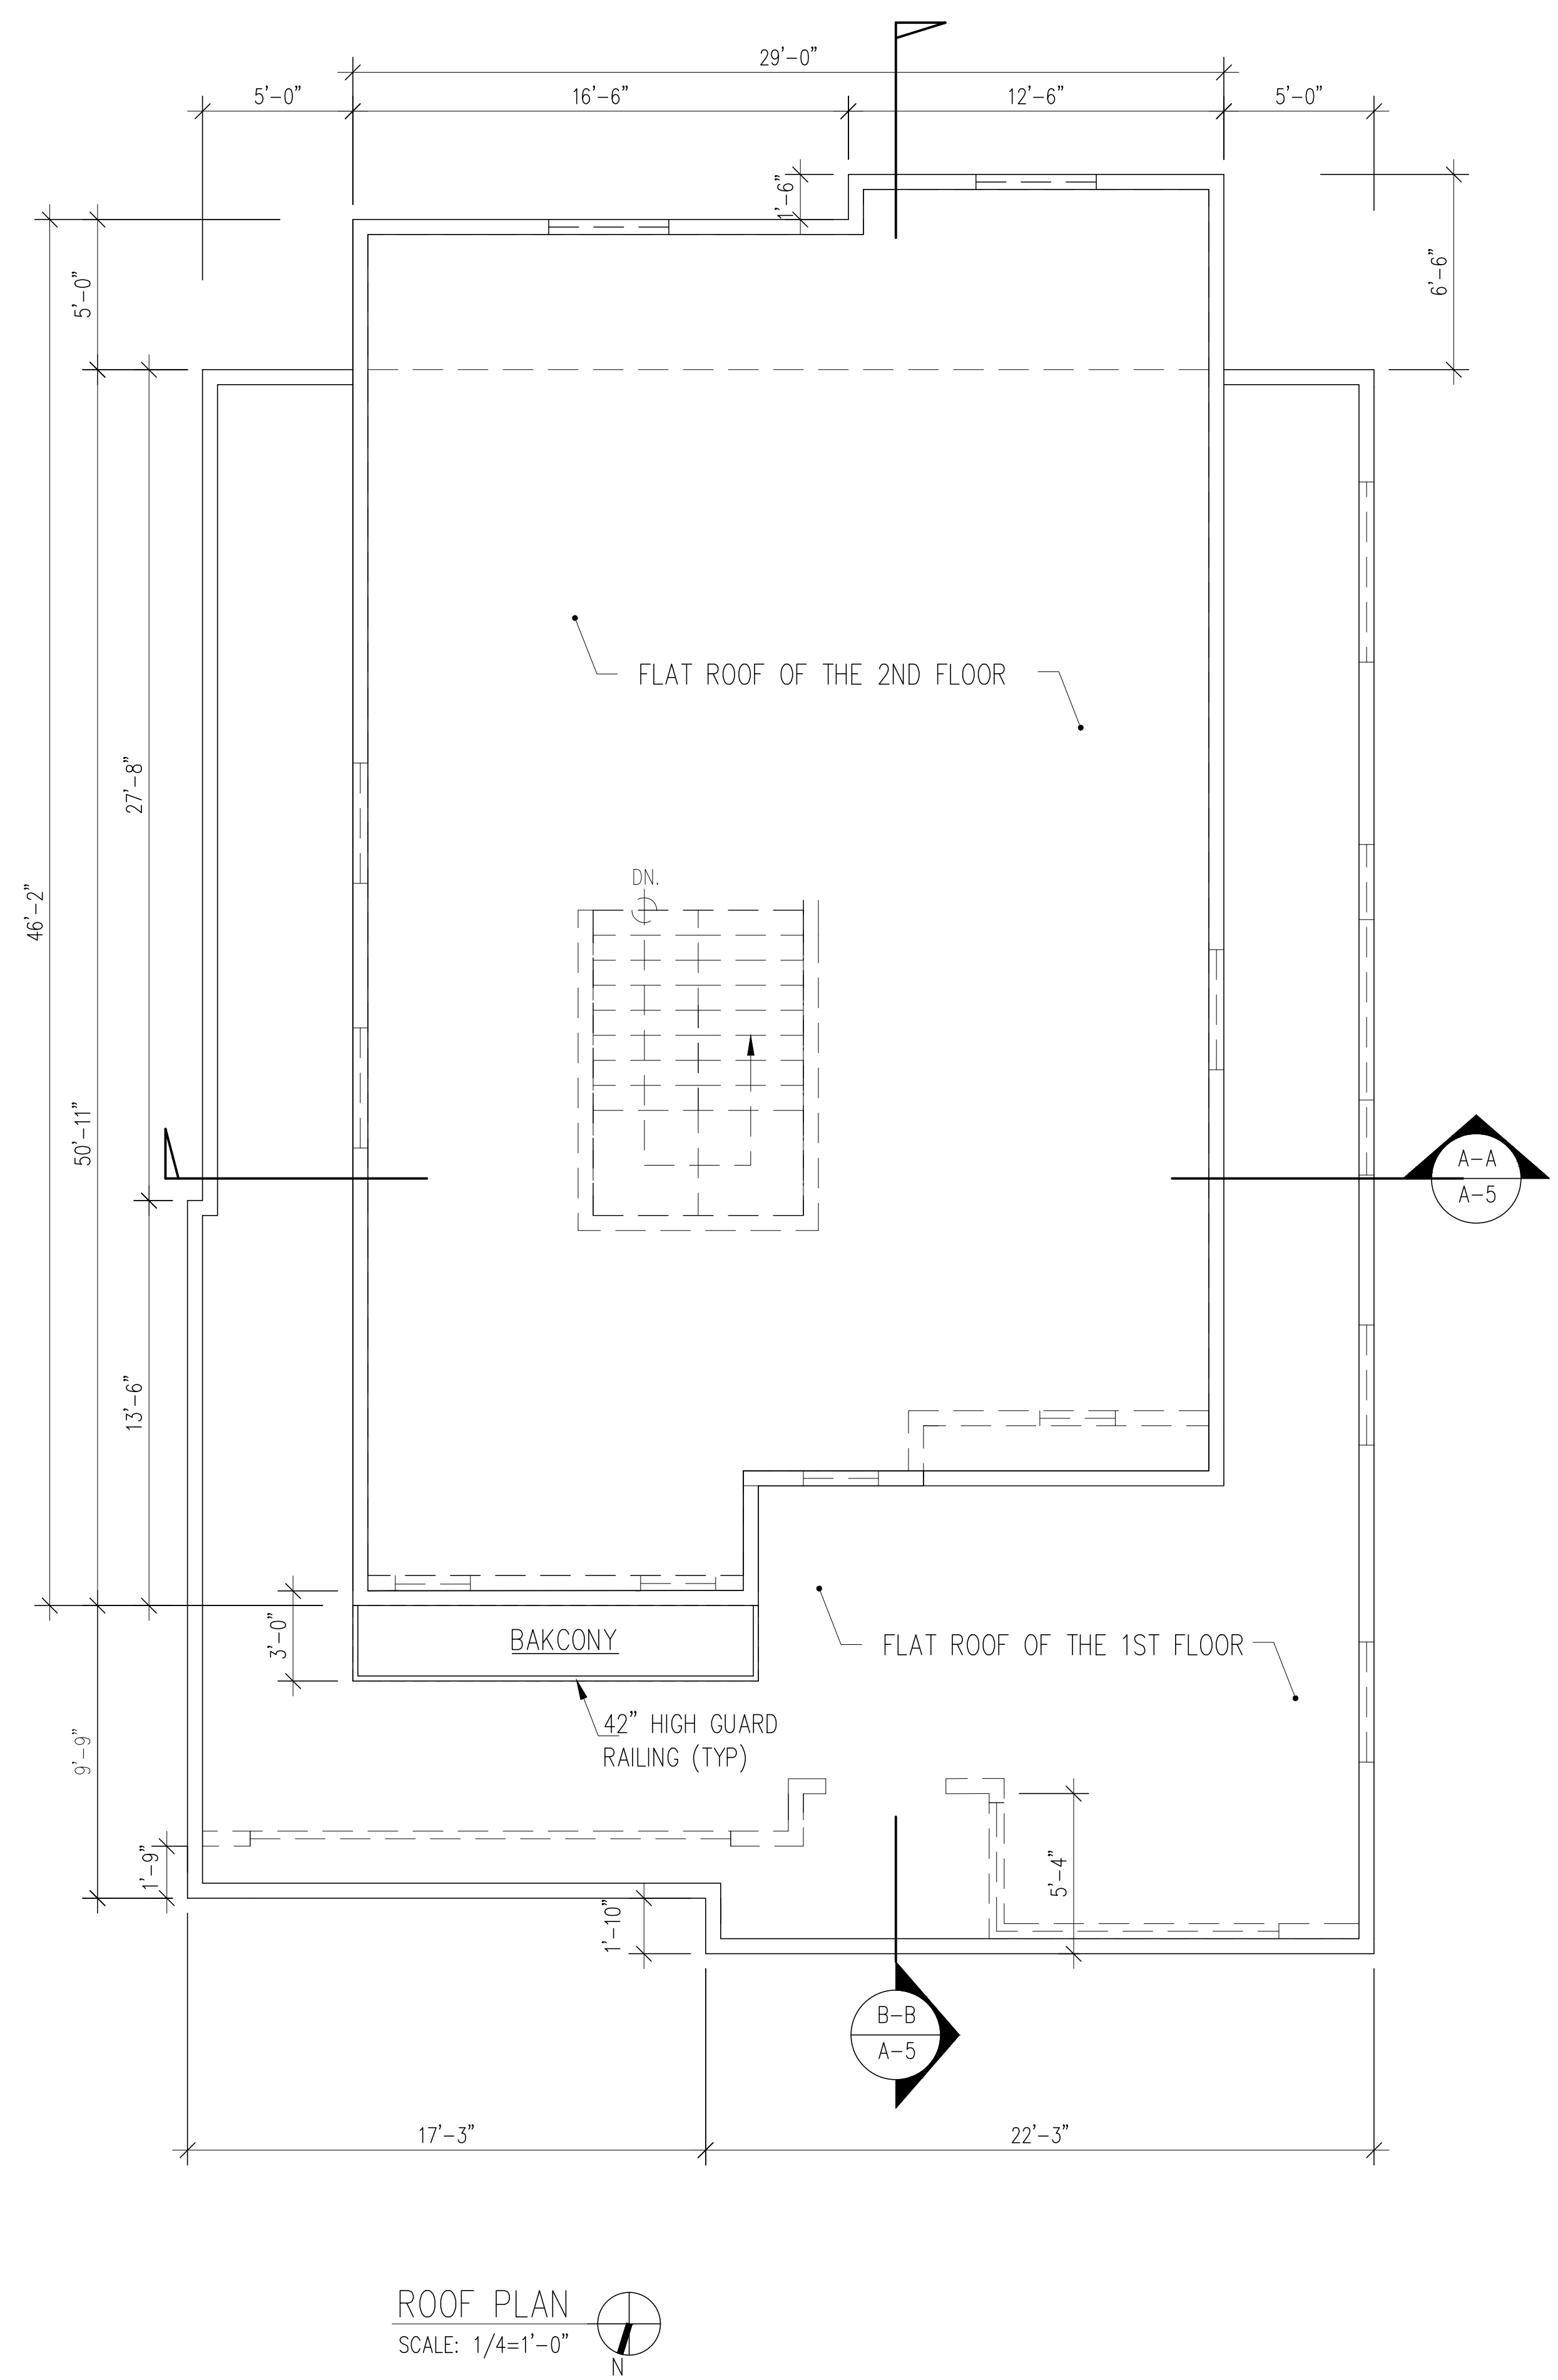
WINDOW SCHEDULE						ALL WINDOWS ARE TEMPERED PER HIGH FIRE ZONE	
SYM	SIZE	MATERIAL FRAME/ TRIM	OPERATION	GLAZING	U-FACTOR	SHGC	
1	4'-0"x5'-0" ARCHED	VINYL	FIXED	TEMP. DUAL GLAZED	0.30	0.21	
2	NOT USED		NOT USED		NOT USED		
3	4'-0"x5'-0"	VINYL	SINGLE HUNG	DUAL GLAZED	0.30	0.21	
4	3'-0"x10'-0" WIN.	VINYL	FIXED	TEMP. DUAL GLAZED	0.30	0.21	
5	1'-6"x8'-0" WIN.	VINYL	FIXED	TEMP. DUAL GLAZED	0.30	0.21	
6	D=2'-0" CIRCLE SHAPE	VINYL	CASEMENT	TEMP. DUAL GLAZED	0.30	0.21	
7	4'-0"x6'-0"	VINYL	CASEMENT	DUAL GLAZED	0.30	0.21	
8	2'-0"x5'-0"	VINYL	CASEMENT	TEMP. DUAL GLAZED	0.30	0.21	
9	4'-0"x6'-0"	VINYL	CASEMENT	DUAL GLAZED	0.30	0.21	
10	11'-0"x5'-0" WIN.	VINYL	CASEMENT	DUAL GLAZED	0.30	0.21	
11	6'-0"x5'-0"	VINYL	CASEMENT	DUAL GLAZED	0.30	0.21	
12	3x(4'-0"x8'-0")	VINYL	FIXED	DUAL GLAZED	0.30	0.21	
13	4'-0"x4'-6"	VINYL	CASEMENT	DUAL GLAZED	0.30	0.21	
14	2'-6"x3'-0" ARCHED	VINYL	CASEMENT	TEMP. DUAL GLAZED	0.30	0.21	
15	3'-6" x 8'-0"	VINYL	FIXED	DUAL GLAZED	0.30	0.21	

NOTE:

1. BEDROOM EGRESS WINDOWS SHALL HAVE A MINIMUM AREA OF 5.7 SF. MINIMUM NET HEIGHT: 24" AND MINIMUM NET WIDTH: 20". SILL HEIGHT SHALL BE 44" MAXIMUM ABOVE FINISH FLOOR WINDOW AREA OF 1/10 OF THE FLOOR AREA WITH 50% OF WINDOW AREA OPENABLE.

2. THE NFRC TEMPORARY LABEL DISPLAYED ON WINDOWS AND SKYLIGHTS (INCL. TUBULAR) MUST REMAIN ON THE UNIT UNTIL FINAL INSPECTION HAS BEEN COMPLETED.

DOOR SCHEDULE							
MARK	DOOR				REMARKS	U-FACTOR	SHGC
(NO.)	DESCRIPTION	SIZE	DOOR MAT'L	FRAME MAT'L			
1	ENTRY DOOR	4'-0"x 8'-0"x1 3/4"	METAL/GLASS	METAL	TEMPERED, DUAL GLAZED	0.30	0.21
2	DR. LEADING TO GARAGE	3'-0"x8'-0"x1 3/4"	WOOD	WOOD	20 MIN. W/ SELF CLOSING & SELF LATCHING		
3	GARAGE DOOR	16'-0"x7'-0" ARCHED	METAL	METAL	OVERHEAD		
4	BATH/ BEDROOM/ W.I.C	2'-8"x8'-0"x1 3/8"	WOOD	WOOD	SOLID CORE		
5	DOUBLE DOORS	(2)-2'-8"x10'-0"x1 3/4"	GLASS	VINYL	TEMPERED GLASS FRENCH SWING DOORS, DUAL GLAZED	0.30	0.21
6	INTERIOR DOUBLE DOORS	(2)-2'-8"x8'-0"x1 3/4"	WOOD	WOOD			
7	DR. LEADING TO BASEMENT	3'-0"x6'-8"x1 3/4"	WOOD	WOOD	20 MIN. W/ SELF CLOSING & SELF LATCHING		
8							
9							
10							



OWNER: HAIKAZ SARGISIAN
4210 W. NATIONAL AVE
BURBANK, CA. 91505
(424) 888-0909

ARCHITECT/DESIGNER: ART CONSTRUCTION SERVICES
144 S. First St., suite 201, Burbank, CA, 91502
TEL (818) 563-1160, FAX (818) 563-1160
ENGINEER: ~~~~~
144 S. First St., suite 201, Burbank, CA, 91502
TEL (818) 563-1160, FAX (818) 563-1160

PROJECT: (N) 2-STORY S.F.D. W/ ATTACHED 2-CAR GARAGE


ADDRESS: 4210 W. NATIONAL AVE.
BURBANK, CA. 91505

JOB NO: ** **


SHEET TITLE
ROOF PLAN;
DOOR/WINDOW
SCEDULES

NOT FOR CONST.
ISSUED FOR PERMIT
ISSUED FOR CONST.
DATE: 01-05-2021
SCALE: 1/4"=1'-0" U.N.O.
SHEET NO.


A-3

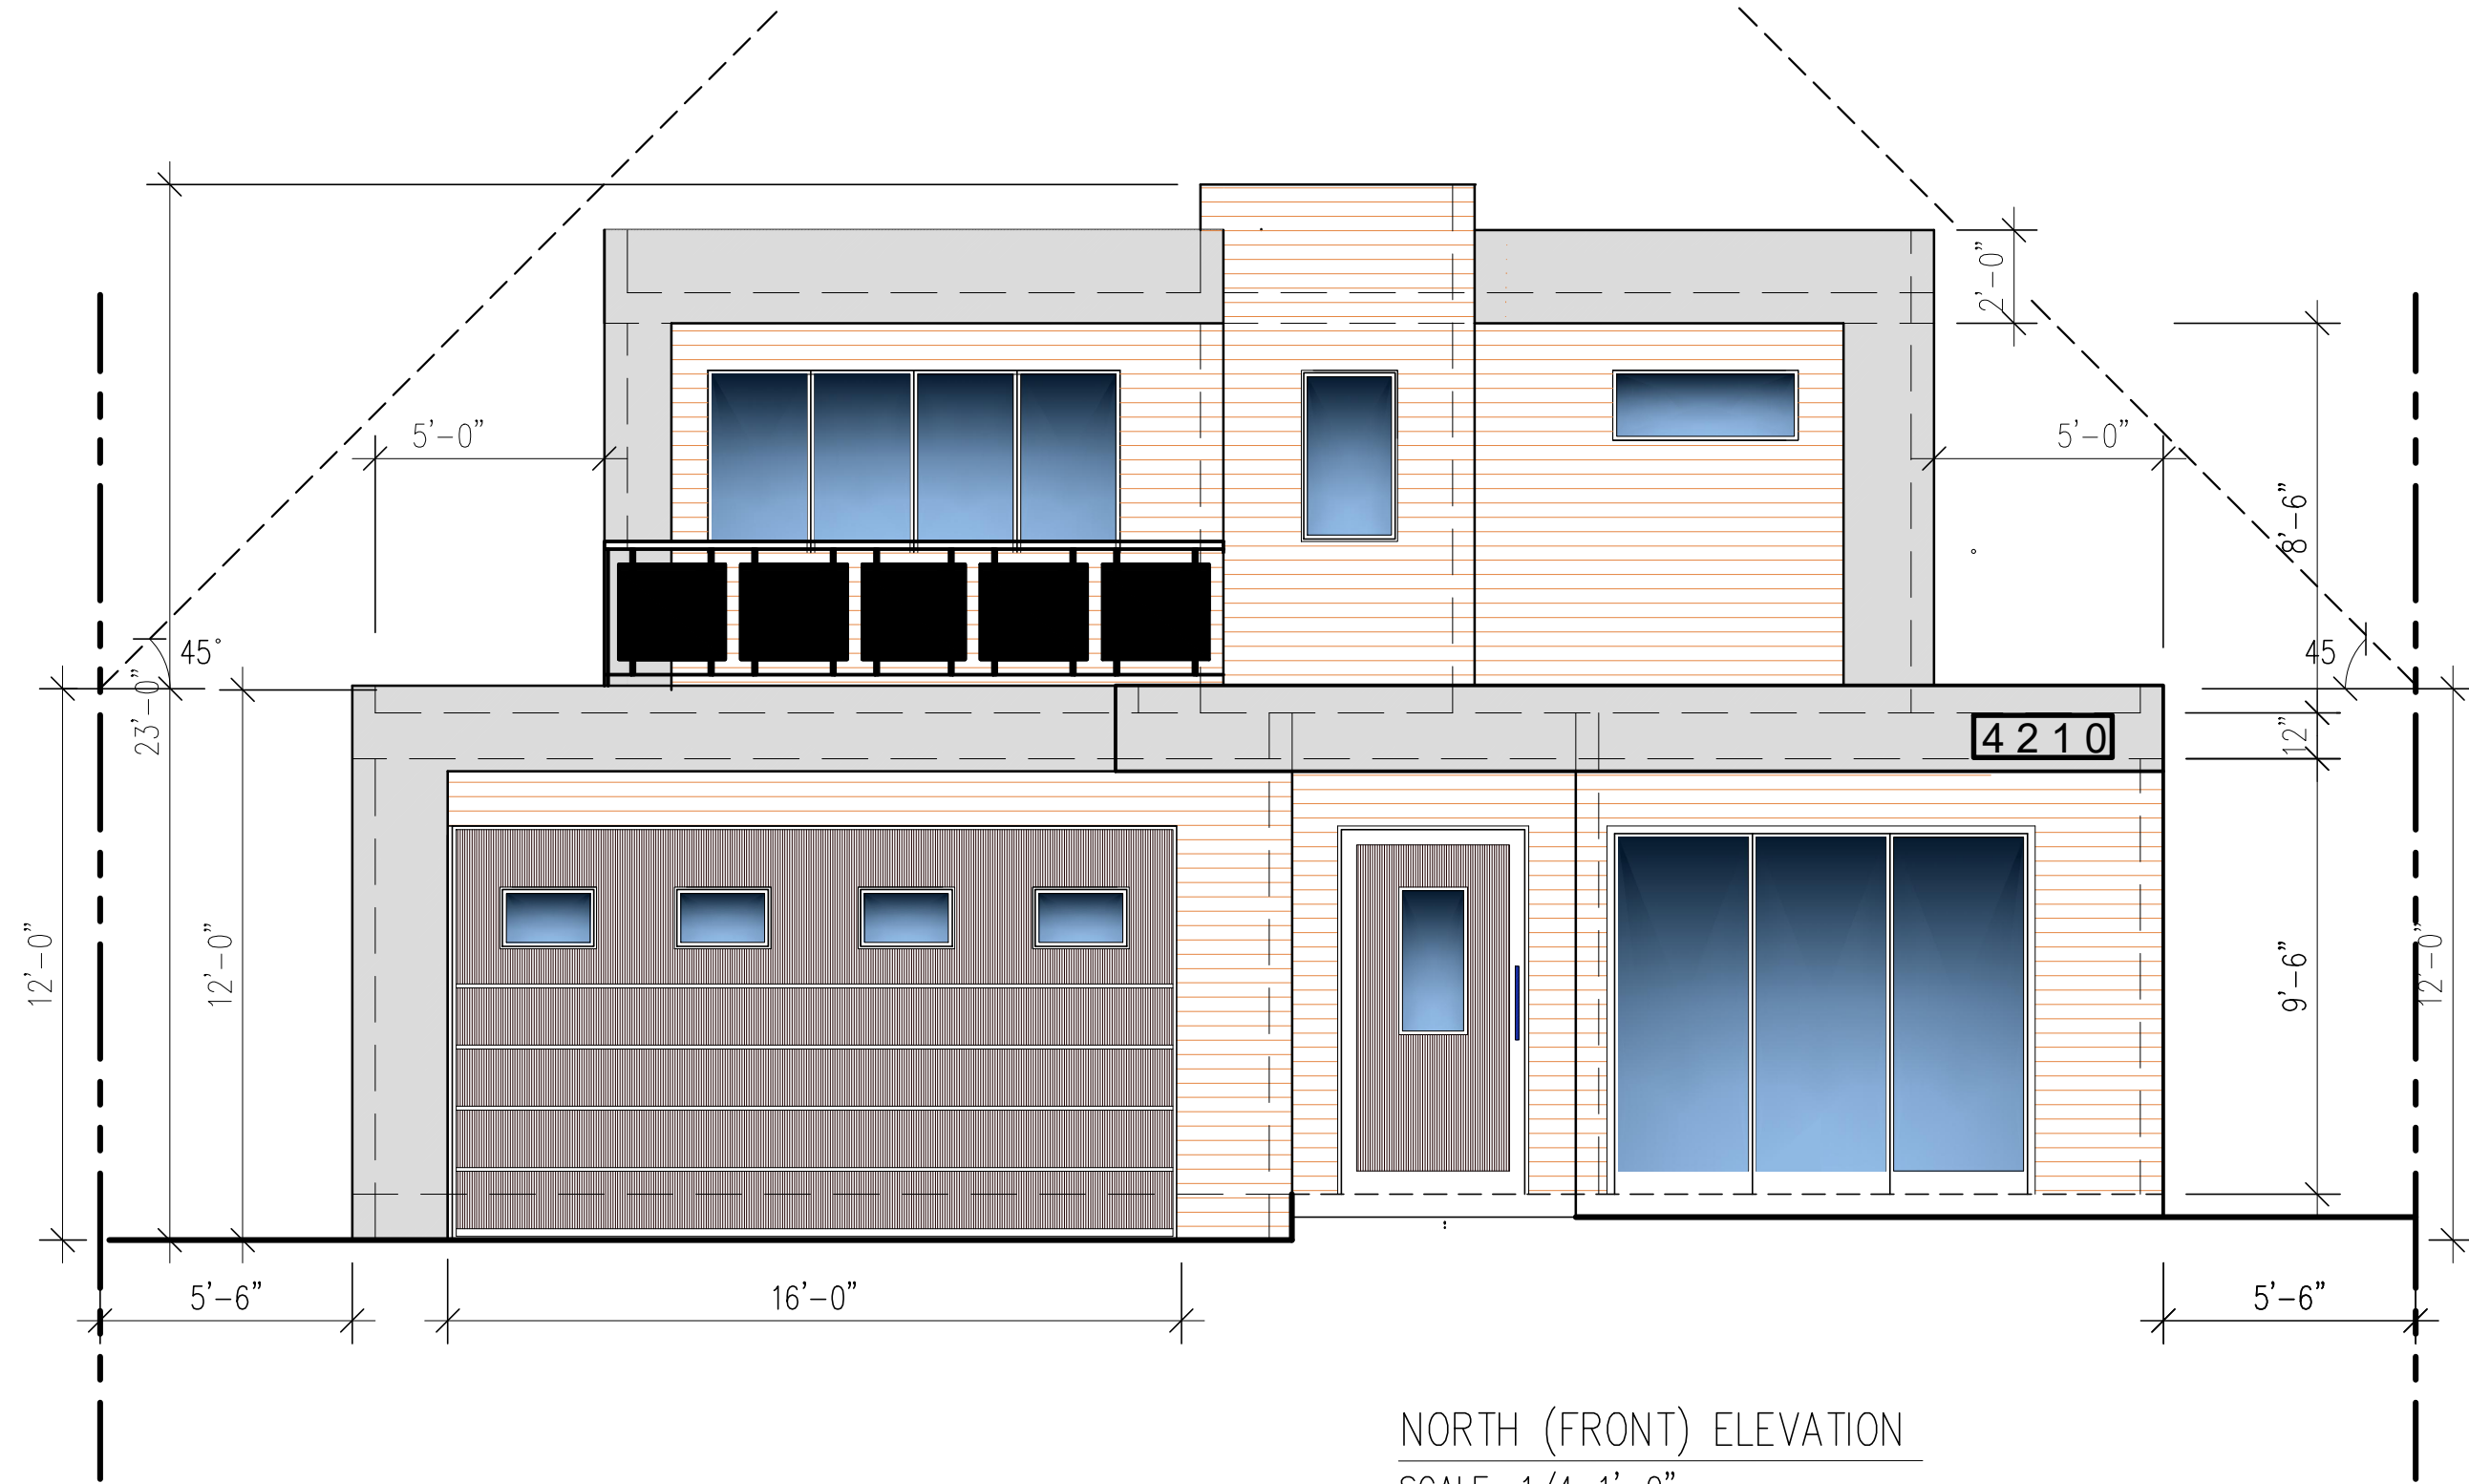

NORTH (FRONT) ELEVATION
SCALE: 1/4=1'-0"

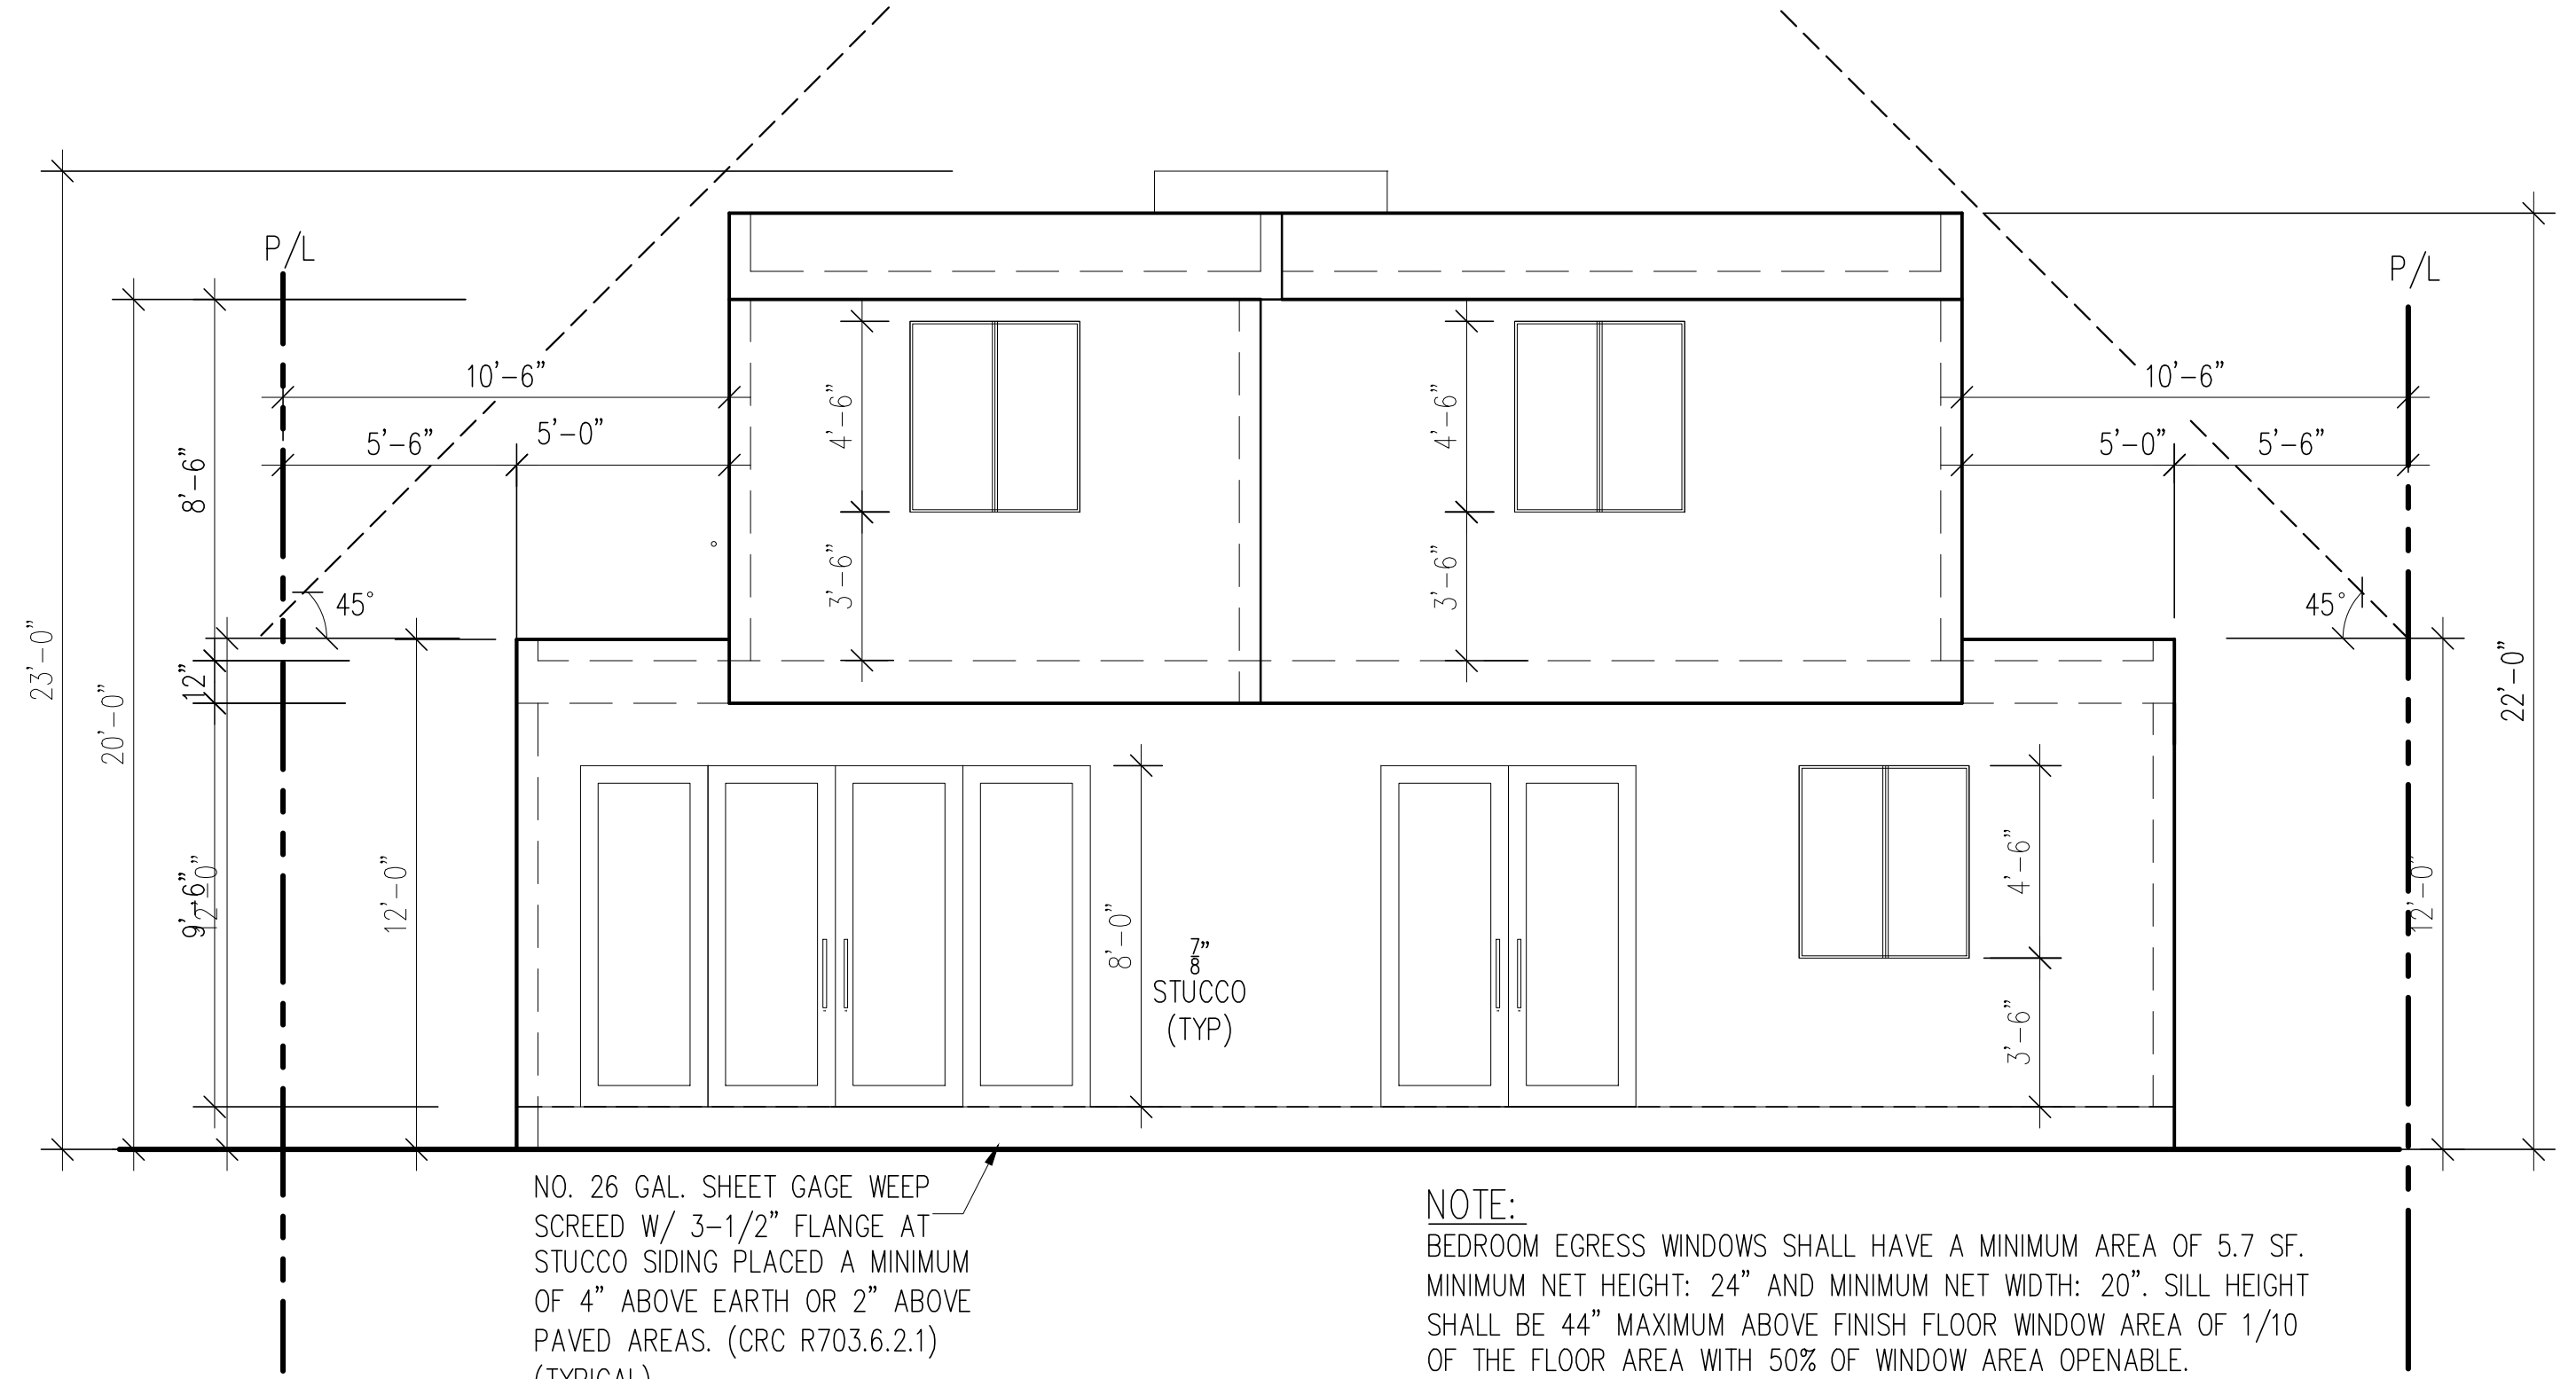

SOUTH (REAR) ELEVATION
SCALE: 1/4=1'-0"

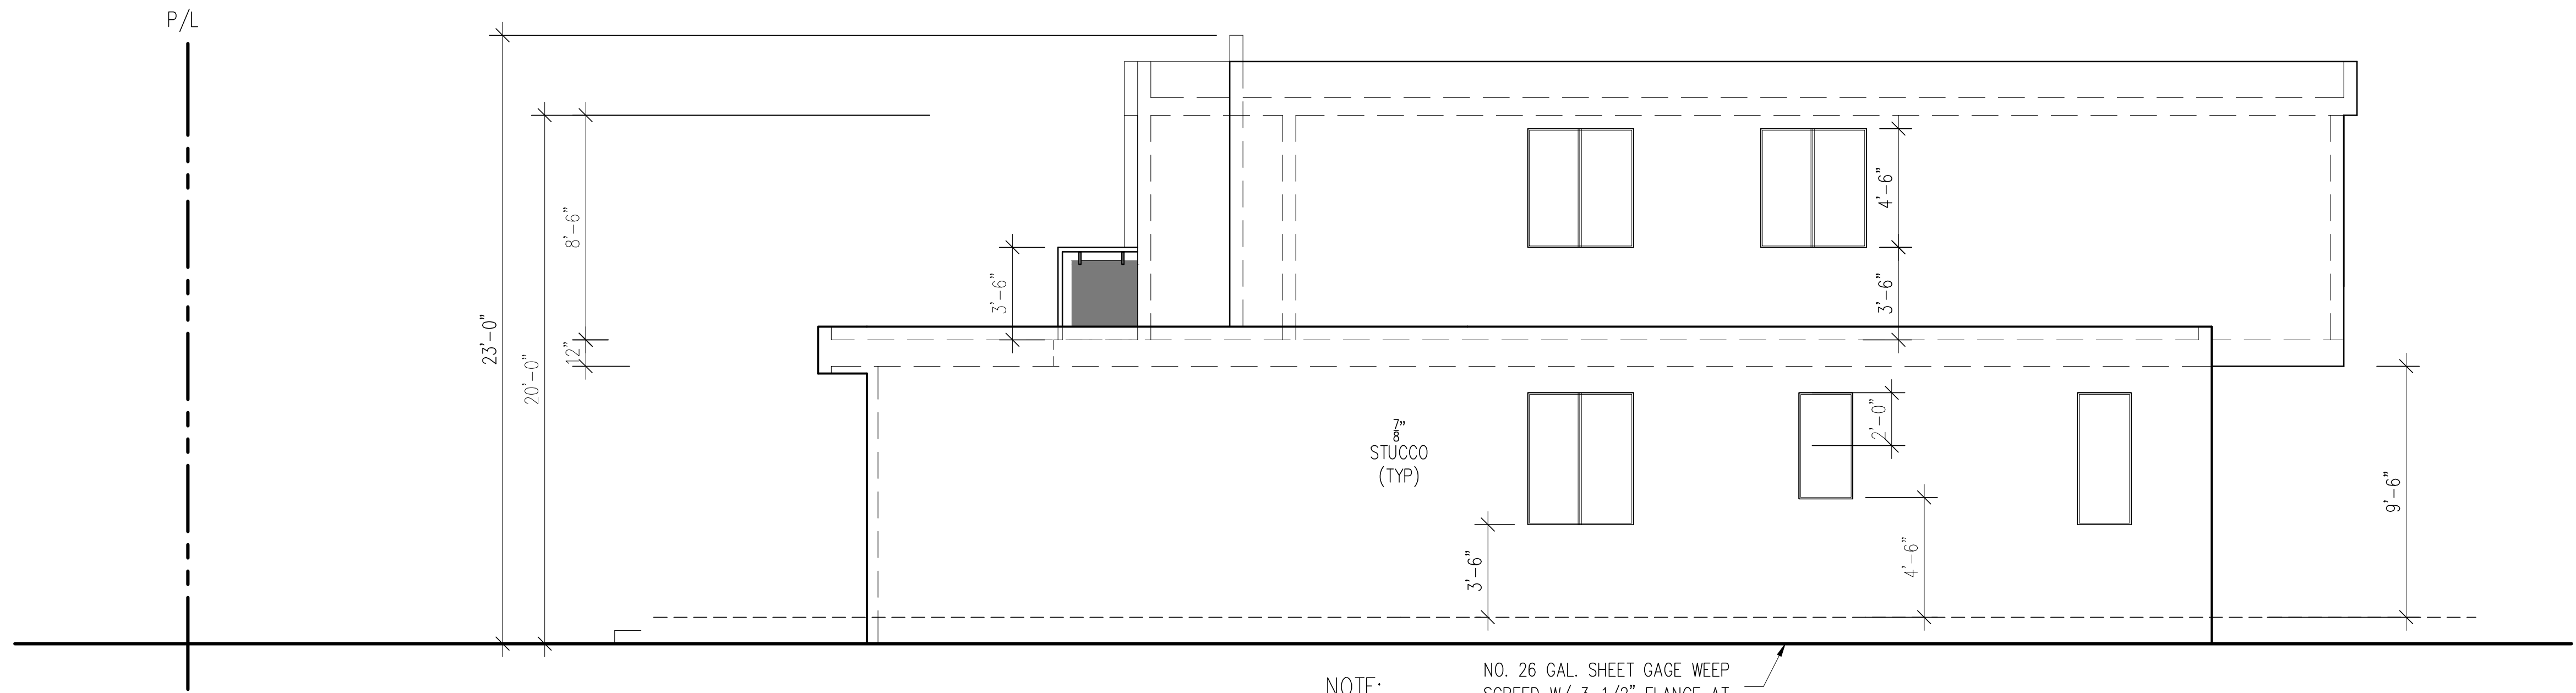

NOTE:
BEDROOM EGRESS WINDOWS SHALL HAVE A MINIMUM AREA OF 5.7 SF.
MINIMUM NET HEIGHT: 24" AND MINIMUM NET WIDTH: 20". SILL HEIGHT
SHALL BE 44" MAXIMUM ABOVE FINISH FLOOR WINDOW AREA OF 1/10
OF THE FLOOR AREA WITH 50% OF WINDOW AREA OPENABLE.

WEST ELEVATION
SCALE: 1/4=1'-0"

NO. 26 GAL. SHEET GAGE WEEP
SCREED W/ 3-1/2" FLANGE AT
STUCCO SIDING PLACED A MINIMUM
OF 4" ABOVE EARTH OR 2" ABOVE
PAVED AREAS. (CRC R703.6.2.1)
(TYPICAL)

NOTE:
BEDROOM EGRESS WINDOWS SHALL HAVE A MINIMUM AREA OF 5.7 SF.
MINIMUM NET HEIGHT: 24" AND MINIMUM NET WIDTH: 20". SILL HEIGHT
SHALL BE 44" MAXIMUM ABOVE FINISH FLOOR WINDOW AREA OF 1/10
OF THE FLOOR AREA WITH 50% OF WINDOW AREA OPENABLE.

PROJECT: (N) 2-STORY S.F.D. W/ ATTACHED 2-CAR GARAGE
ADDRESS: 4210 W. NATIONAL AVE.
BURBANK, CA. 91505

JOB NO: **-**-**
SHEET TITLE


ELEVATIONS

NOT FOR CONST.
ISSUED FOR PERMIT
ISSUED FOR CONST.
DATE: 01-05-2021
SCALE: 1/4"=1'-0" U.N.O.
SHEET NO.

A-4

OWNER: HAIKAZ SARGISIAN
ADDRESS: 4210 W. NATIONAL AVE
BURBANK, CA. 91505
(424) 888-0909

ARCHITECT/DESIGNER:
ART CONSTRUCTION SERVICES
144 S. First St., suite 201, Burbank, CA, 91502
TEL: (818) 363-1160, FAX: (818) 363-1160
ENGINEER:
144 S. First St., suite 201, Burbank, CA, 91502
TEL: (818) 363-1160, FAX: (818) 363-1160

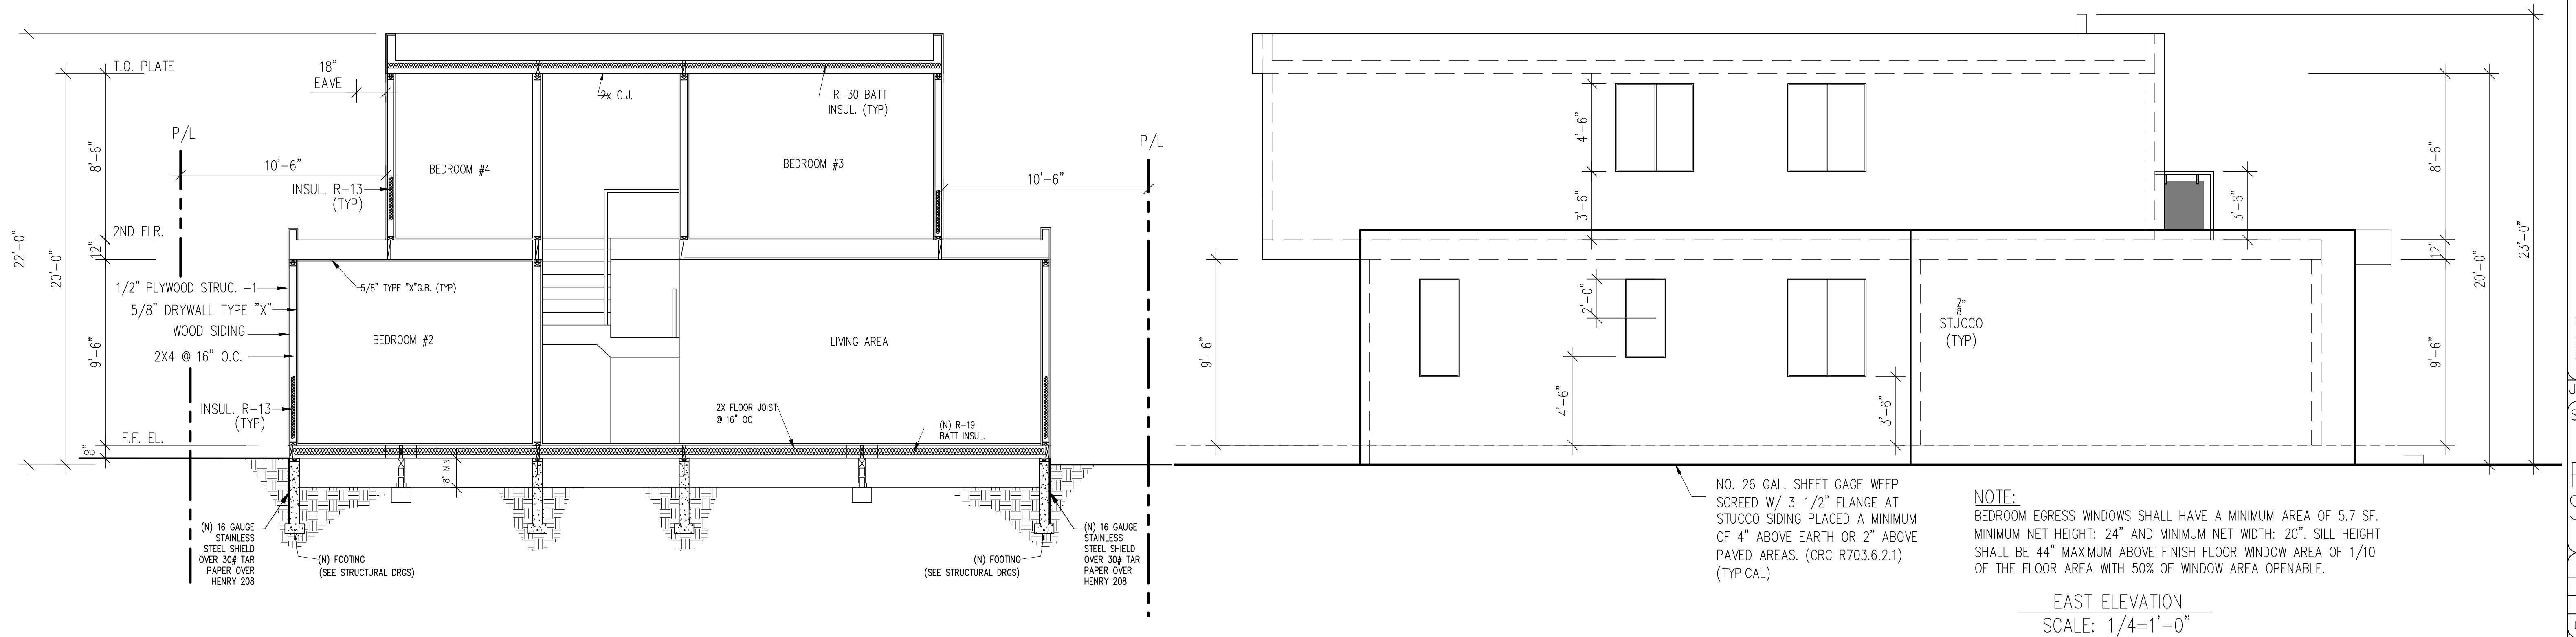


A-5


(N) 2-STORY S.F.D. W/ ATTACHED 2-CAR GARAGE
ADDRESS: 4210 W. NATIONAL AVE.
BURBANK, CA. 91505

HAIKAZ SARGISIAN
4210 W. NATIONAL AVE
BURBANK, CA. 91505
(424) 888-0909

DEMOLITION PLAN

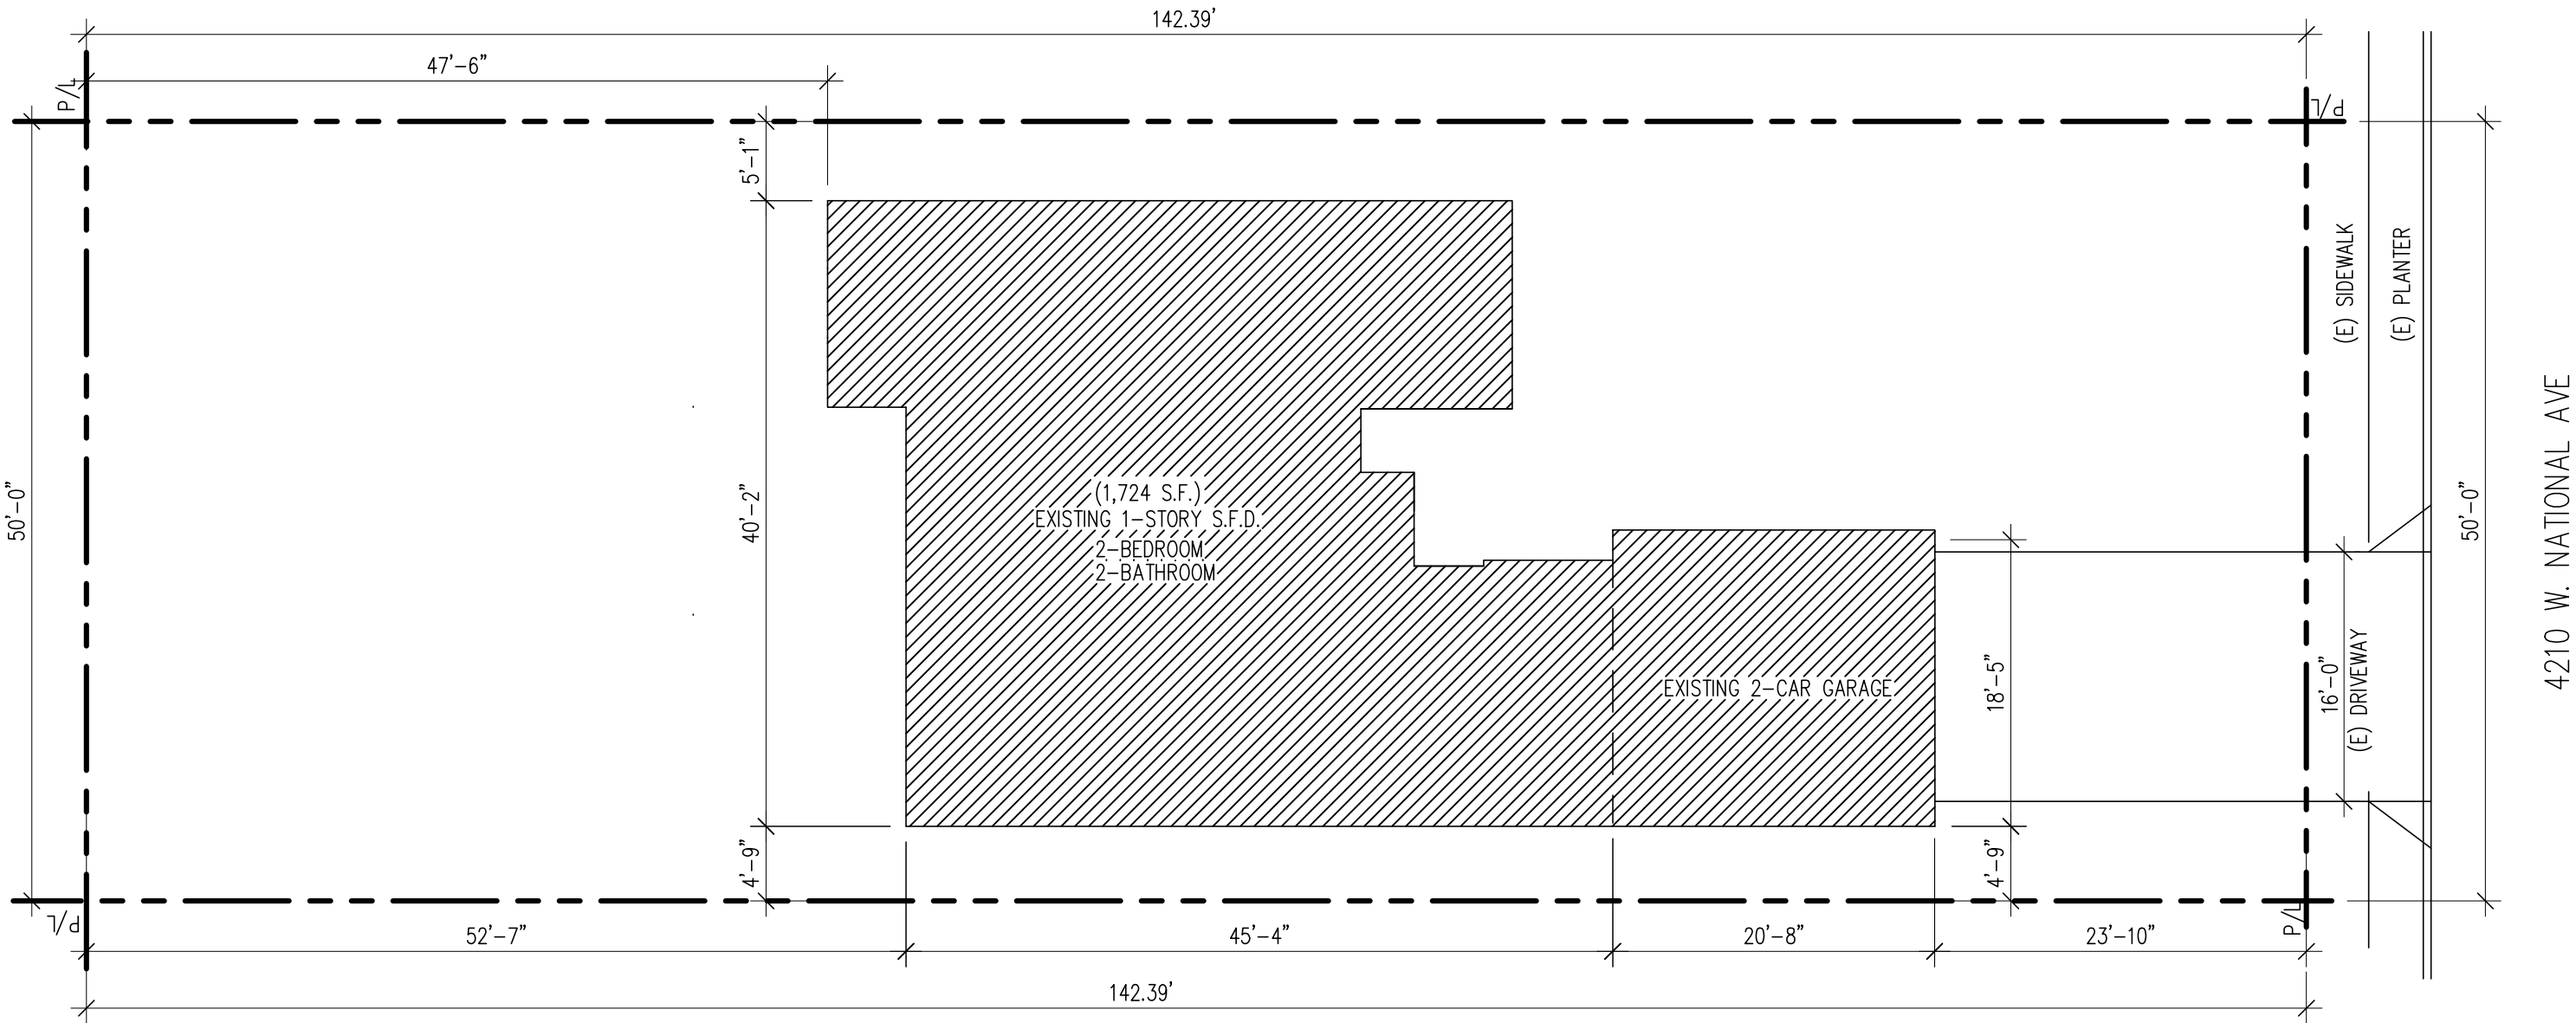

LEGEND

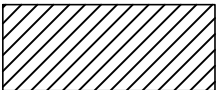


EXISTING 1-STORY S.F.D.
TO BE FULLY DEMOLISHED

(E) PLOT PLAN

SCALE: $\frac{1}{32}" = 1'-0"$

HAIKAZ SARGISIAN

4210 W. NATIONAL STREET
BURBANK, CA 91505
(424) 888-0909

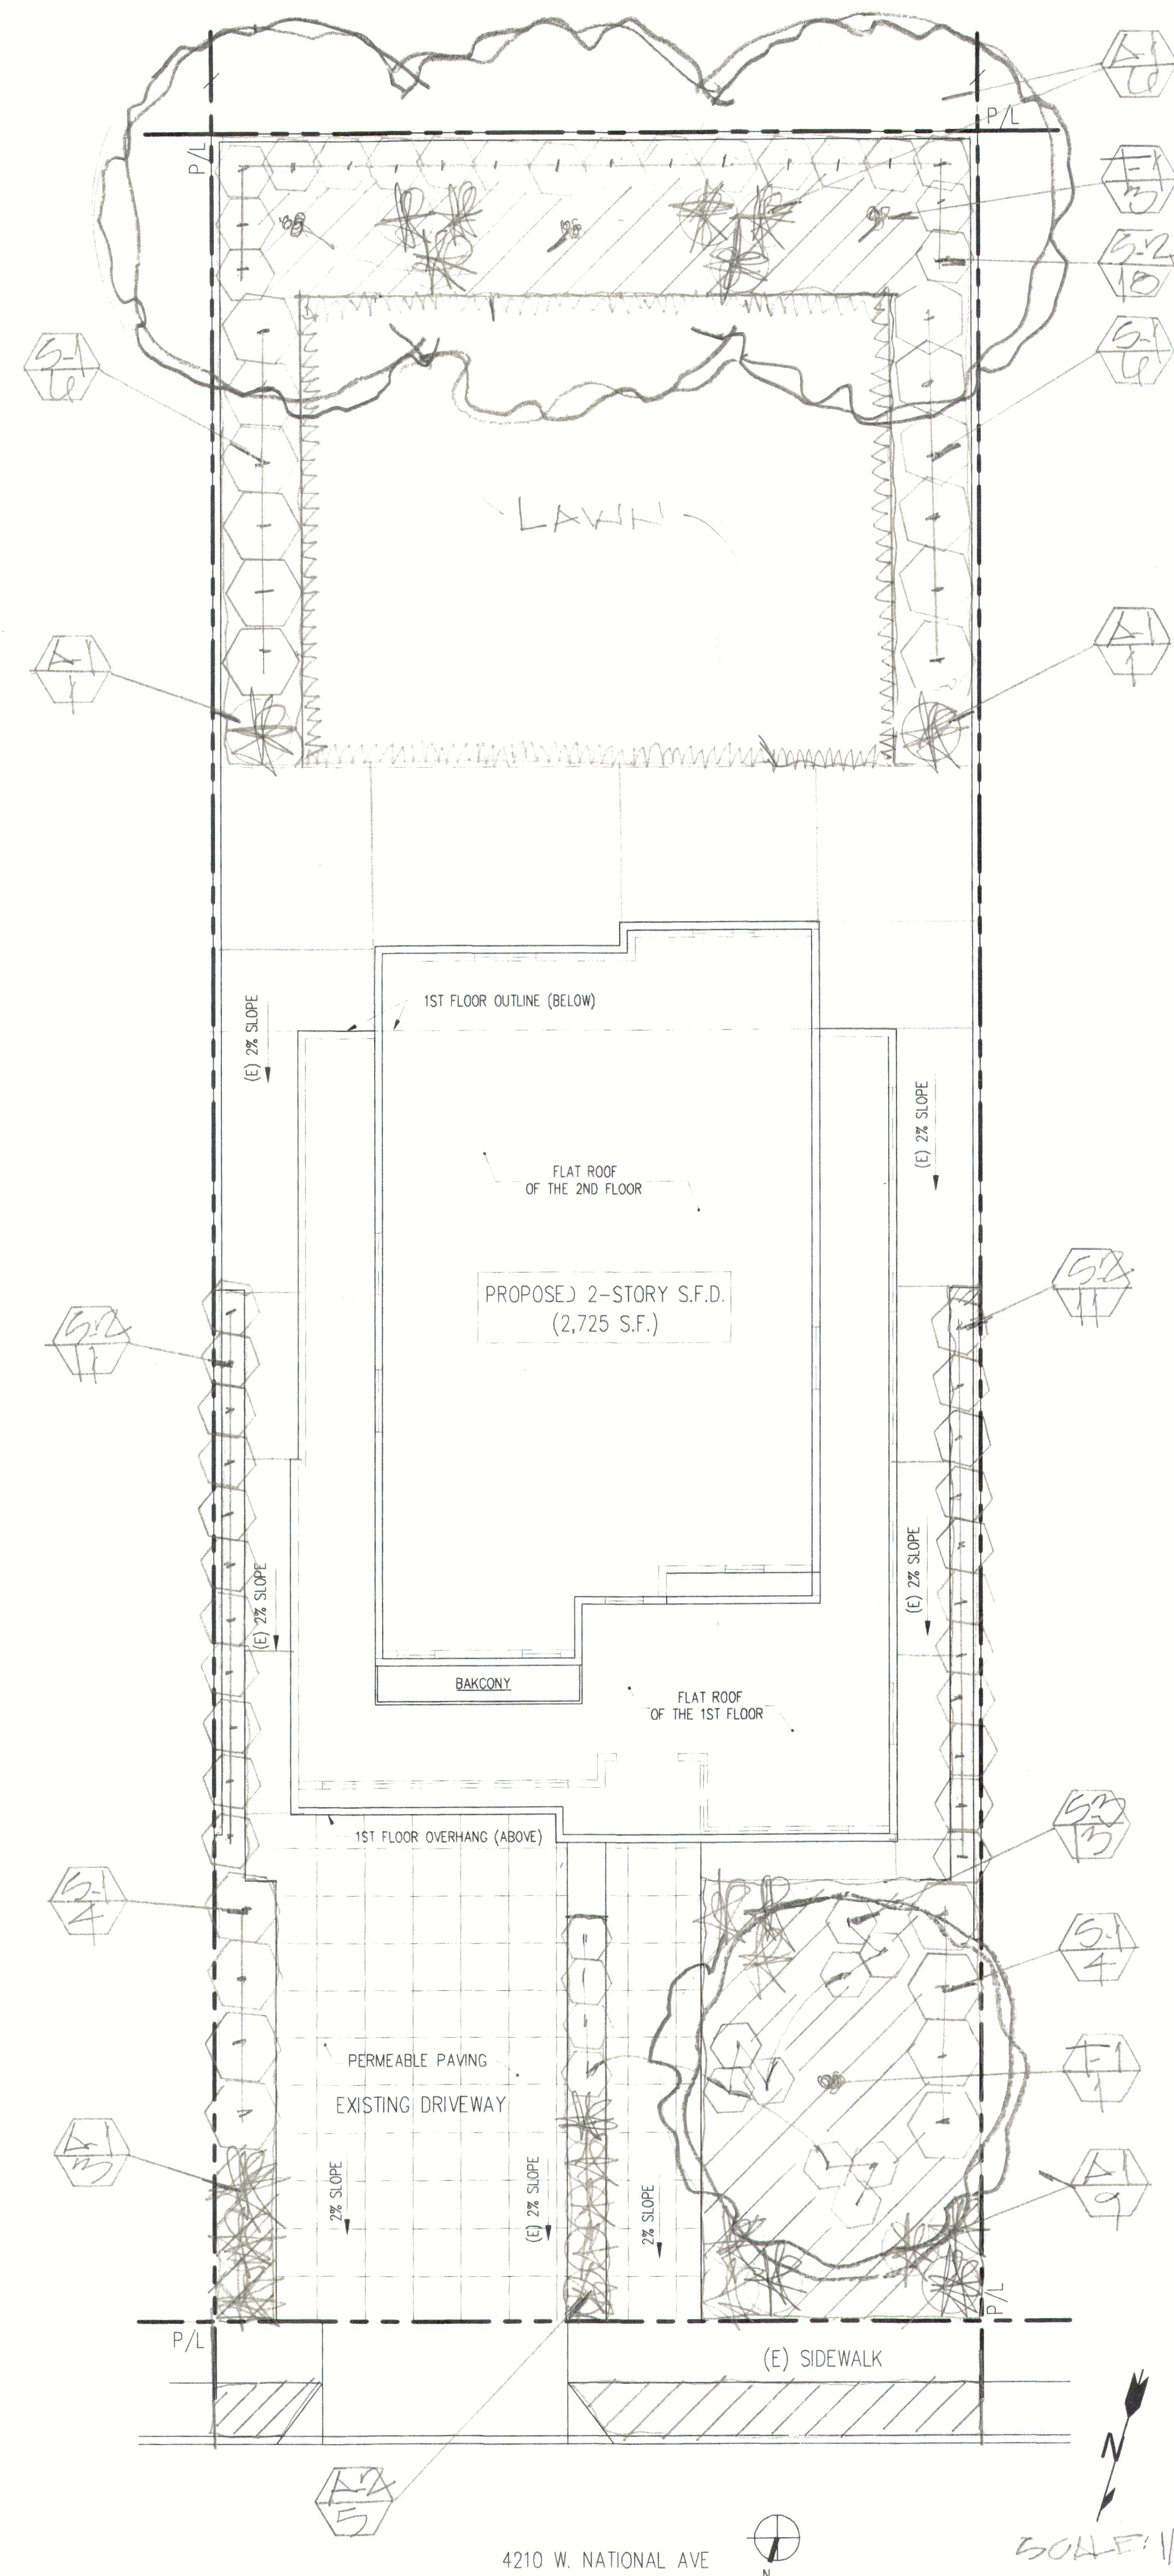

WATER USAGE (WUGS)

PLANT LIST

SYMBOL	BOTANICAL NAME	COMMON NAME	SIZE	QTY.	SPACING
T-1	OLEA EUROPAE 'SMALL HILL'	FRUITLESS OLIVE/MNT.	48"X	4	-
S-1	ROSMARINUS VISCOSSA	HOPBERRY BUSH	56"X	20	5'-0" O.C.
S-2	ALOPECYRUS HUGGELII	BLUE HISSONS	56"X	40	4'-0" O.C.
S-3	LEAVE 'BLUE FLAME'	BLUE FLAME ASH	56"X	15	3'-0" O.C.
A-1	DIETES BICOLOR	FORTNIGHT LILY	56"X	20	RANDOM
A-2	FESTUCA CALIFORNICA	CALIFORNIA FESCUE	56"X	5	"
LAWN	BUCHLOE DACTYLOIDES	BUFFALO GRASS	500	-	-
GROUND COVER	SENECIO SERPENS	BLUE SENECA	FLATS	AS NEEDED	12" O.C.

LW = LOW WATER USAGE / V.E. = .3
 HW = HIGH WATER USAGE / V.E. = .5

LEGEND


- PROPOSED TREE
- PROPOSED SHRUB
- PROPOSED ACCENT
- PROPOSED GROUND COVER
- PLANT SYMBOL QUANTITY

LANDSCAPE AREA = 2,891 S.F.

A MINIMUM 3 INCH LAYER OF MULCH SHALL BE APPLIED ON ALL EXPOSED SOIL SURFACES OF PLANTING AREAS; EXCEPT FOR TURF AREAS, CREEPING OR ROOTING GROUNDCOVERS, OR DIRECT SEEDING. APPLICATIONS WHERE MULCH IS CONTRADICTED. FOR SOILS LESS THAN 6% ORGANIC MATTER IN THE TOP 6" OF SOIL, COMPOST AT RATE OF A MINIMUM OF 4 CUBIC YARDS SOIL PER 1,000 SQUARE FEET OF PERMEABLE AREA SHALL BE INCORPORATED TO A DEPTH OF 6" INTO THE SOIL.

MWELLO COMPLIANCE

I HAVE COMPLIED WITH THE CRITERIA OF THE CALIFORNIA MODEL WATER EFFICIENT LANDSCAPE ORDINANCE AND APPLIED THEM FOR THE EFFICIENT USE OF WATER IN THE LANDSCAPE DESIGN PLAN.

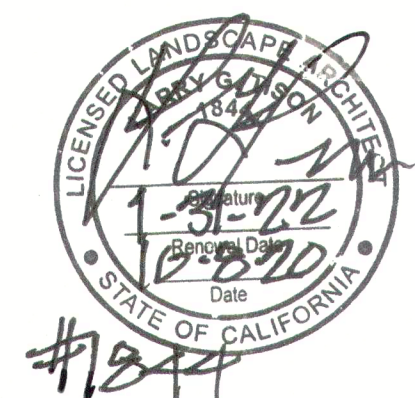

PLANTING PLAN

LARRY G. TISON & ASSOCIATES
 LANDSCAPE ARCHITECTURE
 314 E. BROADWAY, SUITE D, GLENDALE, CALIFORNIA 91205
 818-241-9169

OWNER: HAIKAZ SARGISIAN
 4210 W. NATIONAL AVE
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 (424) 888-0909

ARCHITECT/DESIGNER: ART CONSTRUCTION SERVICES
 144 S. First St., Suite 201, Burbank, CA. 91502
 TEL: (818) 563-1160, FAX: (818) 563-1160


ENGINEER: ~~~~~
 144 S. First St., Suite 201, Burbank, CA. 91502
 TEL: (818) 563-1160, FAX: (818) 563-1160

PROJECT: (N) 2-STORY S.F.D. W/ ATTACHED 2-CAR GARAGE
 ADDRESS: 4210 W. NATIONAL AVE.
 BURBANK, CA. 91505

JOB NO: ** **
 SHEET TITLE

ISSUED FOR PERMIT
 ISSUED FOR CONST.

SCALE: 1/8"=1'-0" U.N.O.
 SHEET NO. L-1

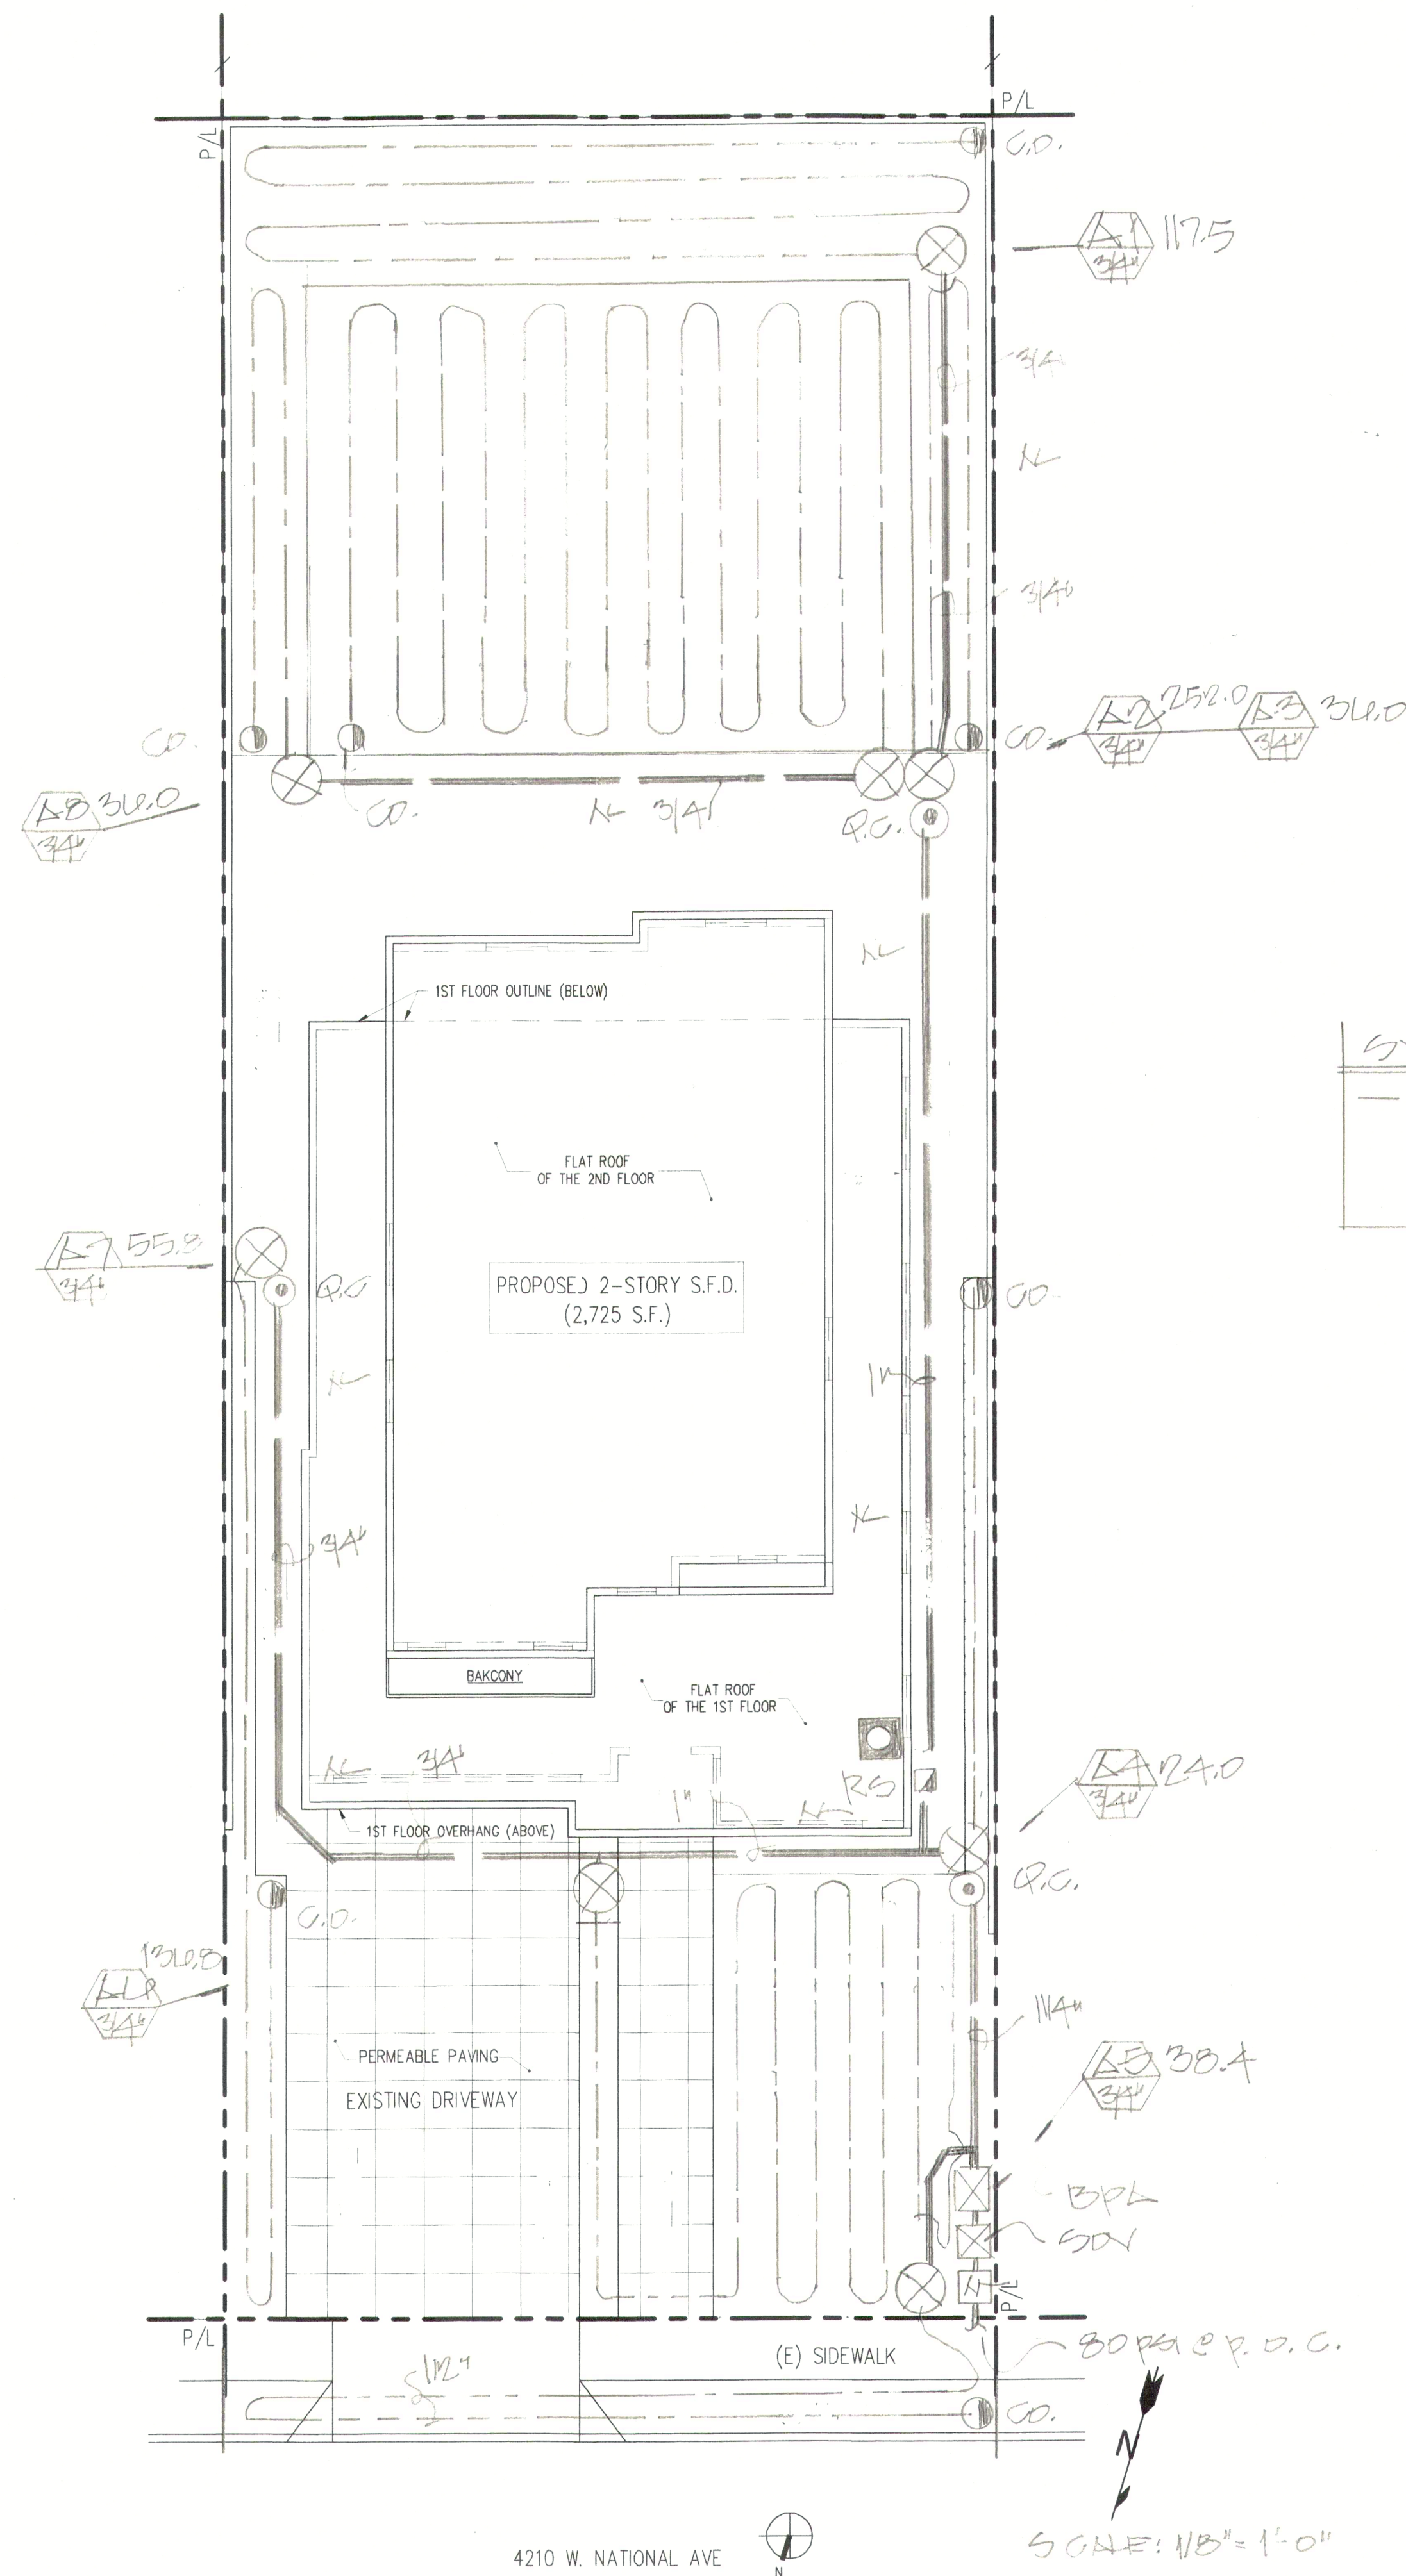

DRIP EMITTERS

SYMBOL	DESCRIPTION	MODEL NO.	GPH	PSI
RA	RAINBIRD DAPHE W/EMITTER 1/2" O.C.	XF500-12-100	100	30

LEGEND

	WEATHER BASED CONTROLLER (RAINBIRD ESP-LXME 8 STATION)
	RAIN SENSOR (RAINBIRD RSD-BEX)
	BACKFLOW PREVENTER (PEBCO 825-Y-1 1/2")
	QUICK COUPLER (RAINBIRD 44LC)
	VALVE (RAINBIRD PEB SERIES)
	VALVE NO. / GPH
	MAINLINE / SCHD. 40 PVC.
	LATERAL LINE / SCHD. 40 PVC
	SHUT-OFF VALVE
	IRRIGATION METER
	GLENHOL

Reference Evapotranspiration (Eto) 15.7

Hydrozone # (Planting Description)	Plant Factor (PF)	Irrigation Method	Irrigation Efficiency (IE)	ETAF (PFIE)	Landscape Area (sq. ft.)	ETAF x Area	Estimated Total Water Use (ETWU)
Regular Landscape Areas							
A-1/1	1.5	DAP	0.3	0.5	490	121.5	5,910
A-2/1	1.5	DAP	0.3	0.5	110	55.5	1,972
A-3/1	1.5	DAP	0.3	0.5	150	75.0	1,972
A-4/1	1.5	DAP	0.3	0.5	57	28.5	1,972
A-5/1	1.5	DAP	0.3	0.5	112	56.0	1,972
A-6/1	1.5	DAP	0.3	0.5	58	29.0	1,972
A-7/1	1.5	DAP	0.3	0.5	112	56.0	1,972
A-8/1	1.5	DAP	0.3	0.5	58	29.0	1,972
A-9/1	1.5	DAP	0.3	0.5	112	56.0	1,972
A-10/1	1.5	DAP	0.3	0.5	58	29.0	1,972
Totals							49,103
Special Landscape Areas							
					1		
					1		
					1		
					1		
Totals							(4)
ETWU Total							49,107
Maximum Allowed Water Allowance (MAWA)							50,963

¹Hydrozone #/Planting Description E.g.
² Front lawn
³ Low water use plantings
⁴ Medium water use plantings

¹Irrigation Method
 overhead spray
 or drip

²Irrigation Efficiency
 0.25 for spray head
 0.45 for drip

³ETWU (Annual Gallons Required) = Eto x 0.62 x ETAF x Area
 where 0.62 is a conversion factor that converts acre-inches per acre per year to gallons per acre per year. LA is the total landscape area in square feet. SLA is the total special landscape area in square feet, and ETAF is .55 for residential areas and 0.45 for non-residential areas.

(15.7) (0.62) (.55) (2,8914) + 10

MAWA = 50,963 GPH

ETWU = 49,107 GPH

CHECK VALVES OR ANTI-DRAIN VALVES ARE REQUIRED ON ALL SPRINKLER HEADS WHERE LOW POINT DRAINAGE CAN OCCUR.

MANUAL SHUT-OFF VALVES SHALL BE REQUIRED; AS CLOSE AS POSSIBLE TO THE POINT OF CONNECTION TO THE WATER SUPPLY. TO MINIMIZE WATER LOSS IN CASE OF EMERGENCY OR ROUTINE REPAIR.

PRESSURE REGULATING DEVICES ARE REQUIRED IF WATER PRESSURE IS BELOW OR EXCEEDS THE RECOMMENDED PRESSURE OF THE SPECIFIED IRRIGATION DEVICES.

A DIAGRAM OF THE IRRIGATION PLAN; SHOWING HYDROZONES SHALL BE KEPT WITH THE IRRIGATION CONTROLLER FOR SUBSEQUENT MANAGEMENT PURPOSES.


A CERTIFICATION OF COMPLETION SHALL BE FILLED OUT AND CERTIFIED BY EITHER DESIGNER OF THE LANDSCAPE PLANS, IRRIGATION PLANS OR THE LICENSED LANDSCAPE CONTRACTOR FOR THE PROJECT.

AN IRRIGATION AUDIT REPORT SHALL BE COMPLETED AT THE TIME OF INSPECTION.

AT THE TIME OF THE FINAL INSPECTION; THE PERMIT APPLICANT MUST PROVIDE THE OWNER OF THE PROPERTY WITH A CERTIFICATE OF COMPLETION, CERTIFICATION OF INSTALLATION, IRRIGATION SCHEDULE OF LANDSCAPE AND IRRIGATION MAINTENANCE.

RECIRCULATING WATER SYSTEMS SHALL BE USED FOR WATER FEATURES.

IRRIGATION PLAN

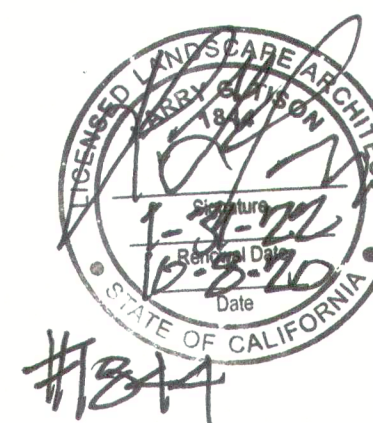

LARRY G. TISON & ASSOCIATES
 LARRY G. TISON, A.S.L.A.
 LANDSCAPE ARCHITECTURE
 314 E. BROADWAY, SUITE D, GLENDALE, CALIFORNIA 91205
 818-241-9159

OWNER: **HAIKAZ SARGISIAN**
 4210 W. NATIONAL AVE
 BURBANK, CA. 91505
 (424) 888-0909

ARCHITECT/DESIGNER: **ART CONSTRUCTION SERVICES**
 144 S. First St., suite 201, Burbank, CA. 91502
 TEL: (818) 563-1160, FAX: (818) 563-1160
 ENGINEER: **ART CONSTRUCTION SERVICES**
 144 S. First St., suite 201, Burbank, CA. 91502
 TEL: (818) 563-1160, FAX: (818) 563-1160

PROJECT: **(N) 2-STORY S.F.D. W/ ATTACHED 2-CAR GARAGE**
 JOB NO: ***
 SHEET TITLE: **IRRIGATION PLAN**

SCALE: 1/8"=1'-0" U.N.O.
 SHEET NO. **L-2**




Tree Root barriers



- Note: This formula is a Std. mix and will change if there are any unusual soil conditions at the site.
Compacted backfill shall be 100% on site soil.



Soil characteristics

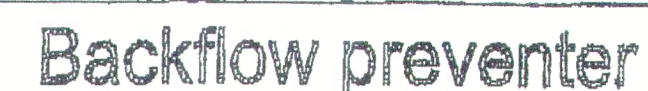

- Note: All other requirements to be per city standards and specifications.





- ### Protection of Existing Tree

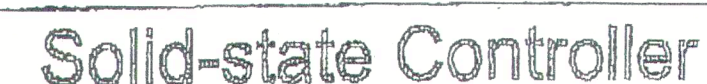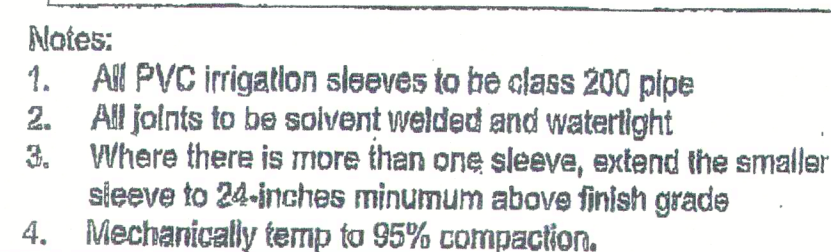

AS BUILT SURVEY FOR
EXISTING HOUSE.

4210 W. NATIONAL AVE.
BURBANK, CA. 91505

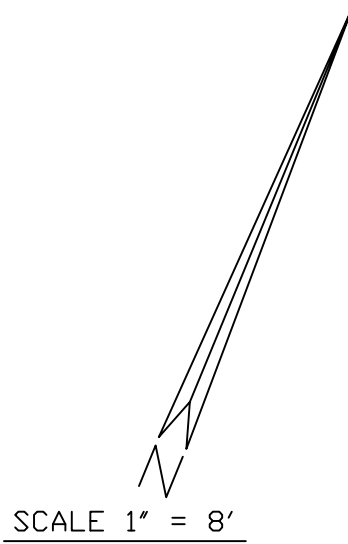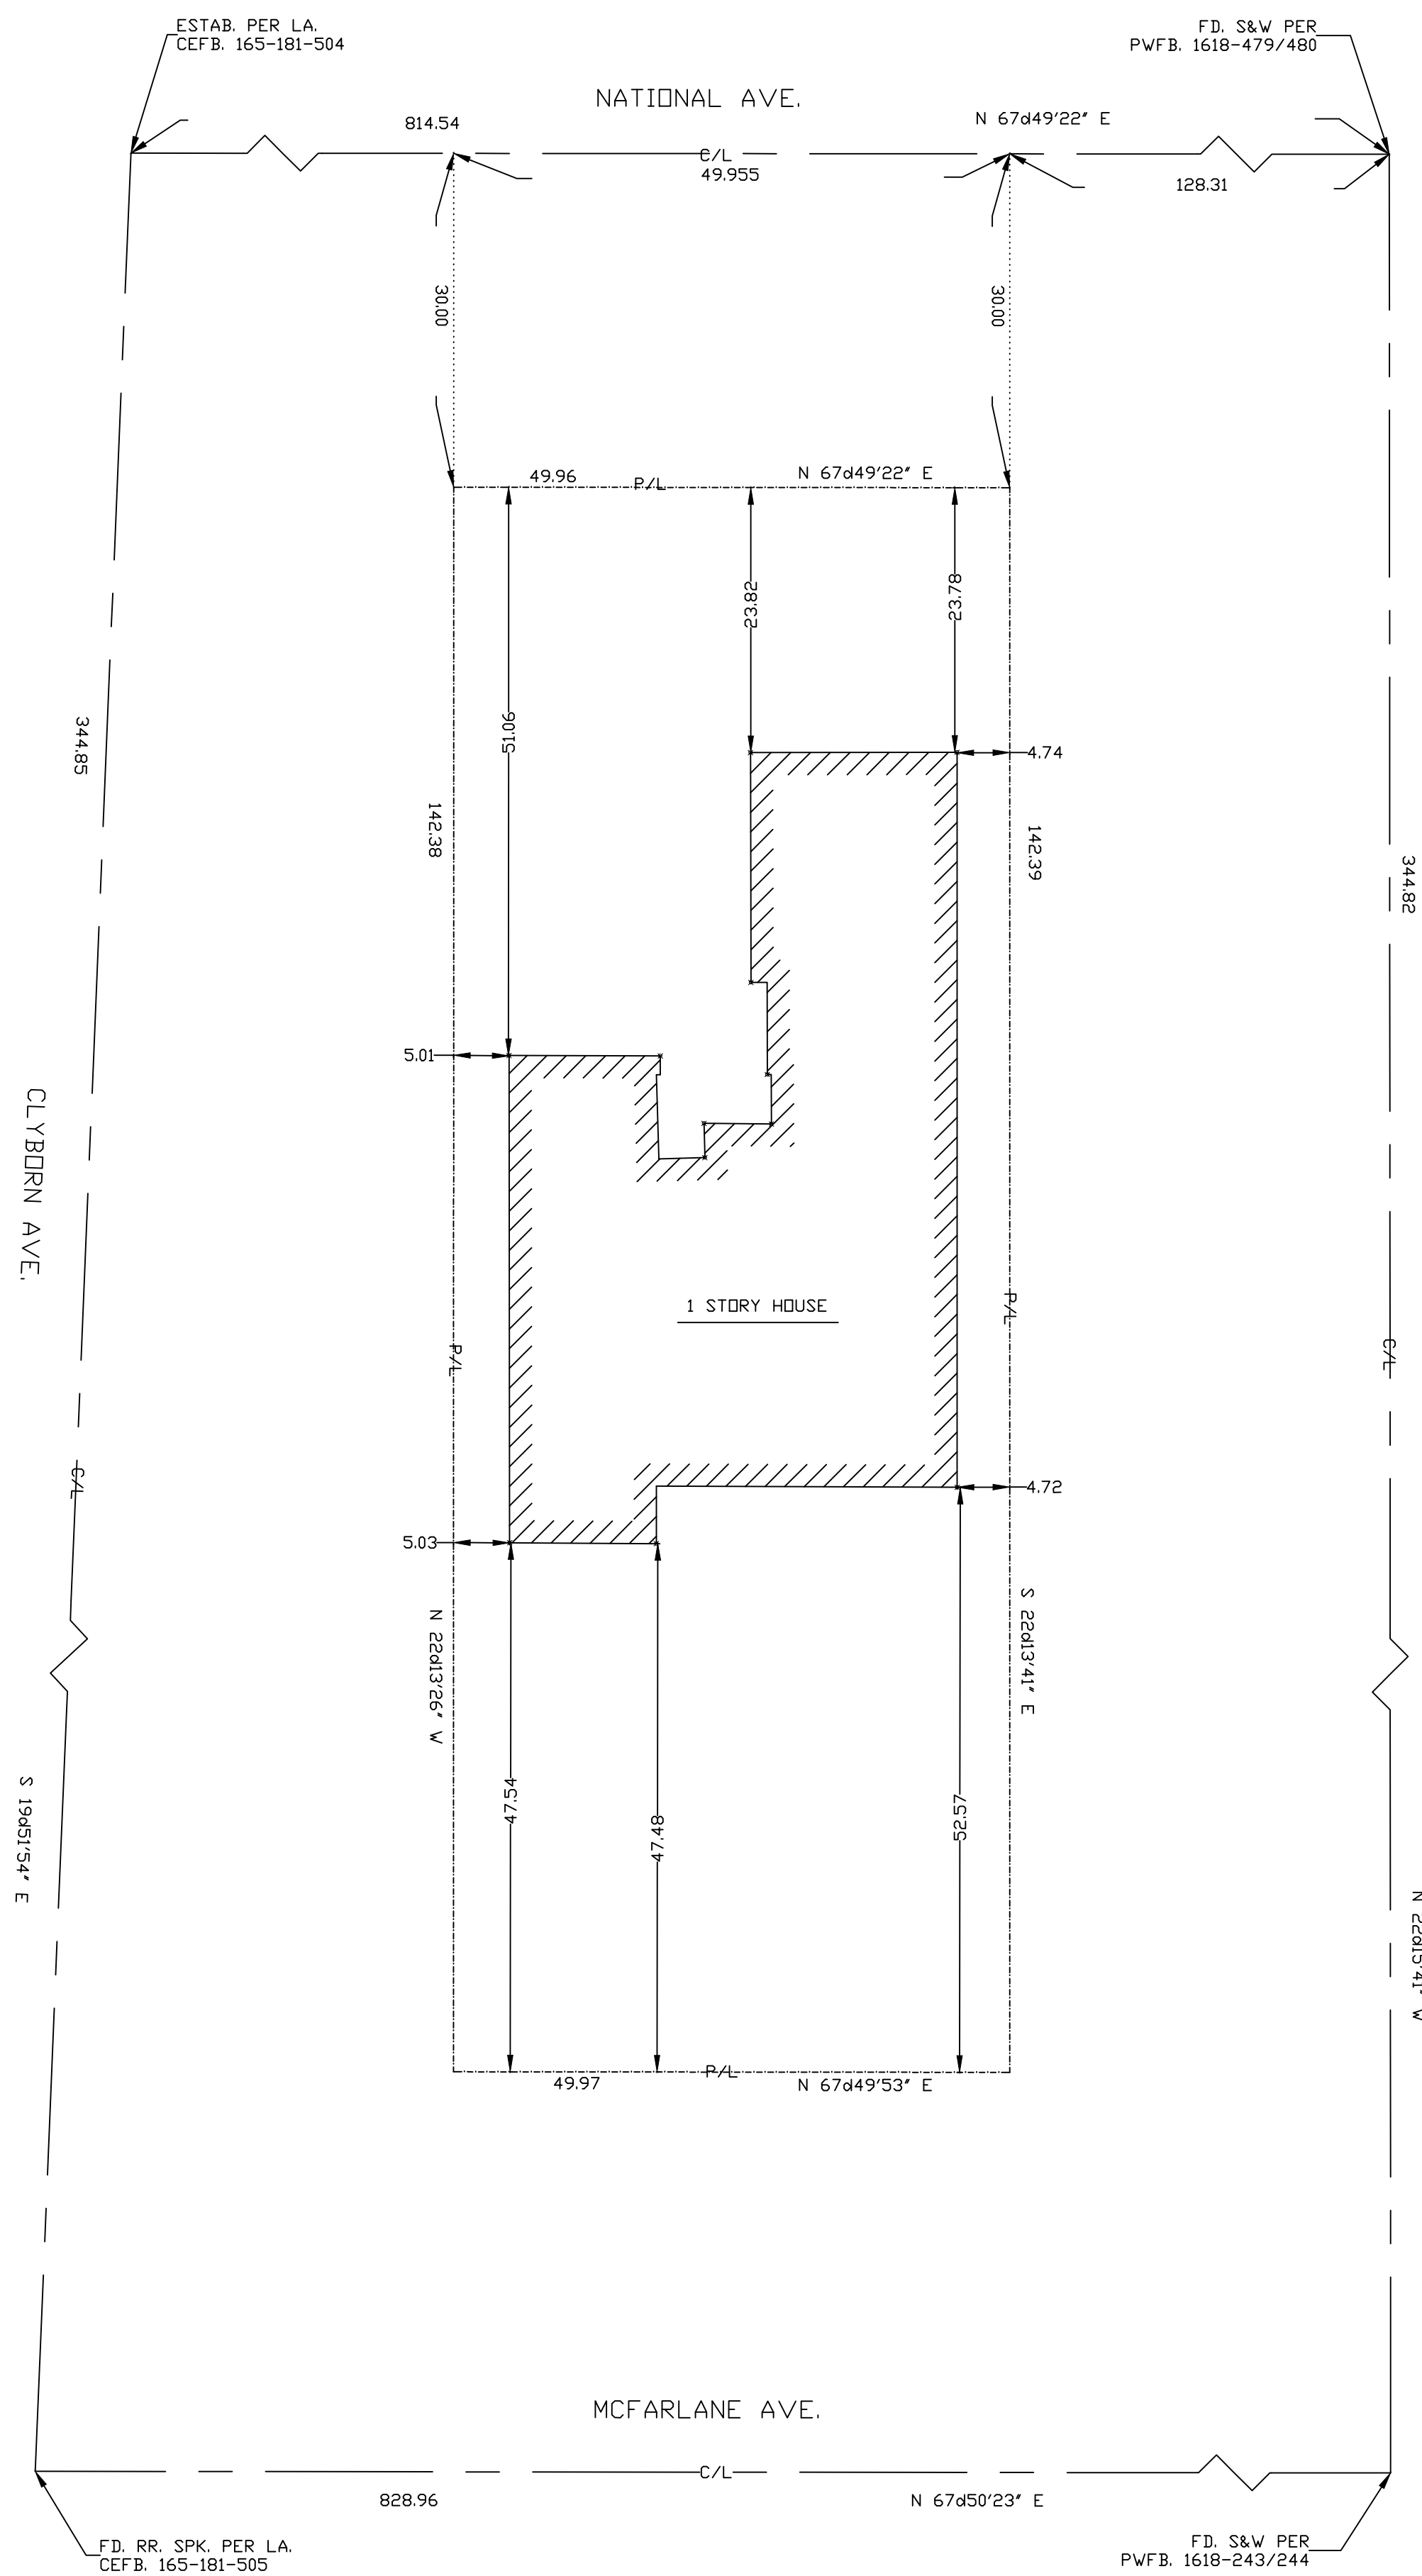

SCALE 1" = 8'

LEGAL DESCRIPTION

LOT 3
TRACT 9477
M.B. 135-89

NOTE
EASEMENTS IF ANY, ARE NOT SHOWN ON THIS SURVEY.

SURVEYED BY: GOR MKRTCHYAN
DATE: 04-16-2019